BARRY SGARRELLA, Chairman DAVE HUSTON, Trustee JASBIR GILL, Trustee

### RECLAMATION DISTRICT NO. 1601 TWITCHELL ISLAND BOARD OF TRUSTEES MEETING TUESDAY, APRIL 16, 2024 9:00 AM ENGINEER'S REPORT

LINDA CARTER, Secretary JESSE W. BARTON, Counsel CHRISTOPHER H. NEUDECK, Engineer RICKY CARTER, Jr., Superintendent PERLA TZINTZUN-GARIBAY, Finance

### I. PROJECT FUNDING AGREEMENT TW – 21 - 1.2 TIMES PROJECT

A. Review the general status of the project process.

### II. DISTRICT EXCAVATOR RECOVERY WITH INSURANCE COMPANY

- A. Review status of the Excavator extraction efforts.
- B. Review Dutra Construction Co. Inc. "Proposal for Excavator Extraction" dated March 29, 2024.

EXHIBIT A: Dutra Construction Co Inc Proposal dated 3/29/24.

EXHIBIT B: Photos of Excavator in January of 2024 and March of 2024.

### III. DISTRICT PUMP STATION SOLAR ARRAY

A. Review status of Solar Array Plans.

EXHIBIT C: KSN Inc. DRAFT Pump Station Solar Array Plans.

### IV. USGS Aloft InSAR FOR LEVEE INSPECTION

A. Review request by Jim Howle, hydrologist with USGS, to deploy monitoring points along District's levee (Levee Station 220+00 to 240+00) adjacent to Sevenmile Slough to perform Aloft Interferometric Synthetic Aperture Radar (InSAR) System testing and ground truthing instruments. This technology and concept are supported by the Department of Water Resources. Recommend Board of Trustees Approval and seek District Counsel to draft permission letter.

EXHIBIT D: Email correspondence from Jim Howell dated Friday 4/5/24.

EXHIBIT E: Excerpt on Aloft InSAR.

## Exhibit A



29 March 2024

Mr. Christopher Neudeck, P.E President, KSN, Inc. 711 N. Pershing Avenue West Sacramento, CA 95691

Subject:

Proposal for Excavator Extraction Services
Reclamation District No. 1601 - Twitchell Island

Dear Mr. Neudeck,

The Dutra Group is pleased to provide this proposal in response to the recent inquiry from KSN regarding the extraction of a Reclamation District excavator that is stuck and buried in a peat field on the district's property.

Understanding the complexity and urgency of the situation, The Dutra Group is well-equipped and experienced in handling such challenging assignments. With our extensive expertise in working in peatlands and a proven track record of successful recoveries, we are confident in our ability to assist in this matter.

Our proposal encompasses a comprehensive approach to the extraction process. We have prepared a Lump Sum price for the removal of the excavator, which includes Mobilization & Demobilization, Excavator Extraction & Removal, and Site Restoration. The price proposal excludes cleanup or removal of any Hazardous Material associated with the excavator.

The proposed scope of work includes:

- 1. Mobilization of necessary equipment, including cranes, dozers, an amphibious excavator, crane mats, wreckers, long reach excavators, and specialized tools.
- 2. Construction of a road using crane mats, potentially supported by a steel truss system, to provide access to the excavator.
- 3. Utilization of an amphibious excavator to access the sunken area and prepare the excavator for extraction.
- 4. Deployment of additional long reach excavators, dozers, and wreckers with high capacity winches to provide the necessary pulling forces for uprighting and extracting the excavator.
- 5. Provision of tools such as sectional barge sections, gin pole mechanisms, skids, and other specialty equipment to facilitate the extraction process.
- 6. Removal of the excavator, transportation off the island, scrapping of excavator
- 7. Repair/ restoration of the field and cleanup post-extraction.

8. Clean up of the equipment, crane mats, and tools used for the extraction effort.

Our proposal stipulates that payment will be contingent upon the successful removal of the excavator. Should extraction efforts prove unsuccessful, The Dutra Group will not seek compensation for the Lump Sum proposal.

### Pricing:

Mobilization & Demobilization: \$ 418,850.00
 Excavator Extraction & Removal: \$1,379,852.00
 Site Restoration 500 tons @ \$159/ton: \$ 79,500.00

We are committed to collaborating closely with Reclamation District No. 1601 and ensuring the successful resolution of this matter in a safe and efficient manner.

We look forward to the opportunity to discuss our proposal further and address any questions or concerns you may have. Please do not hesitate to contact us to arrange a meeting at your earliest convenience.

Thank you for considering our proposal. We appreciate the opportunity to be of service.

Sincerely,

The Dutra Group

Ryan D. Abood

Vice President, Delta Operations

### Exhibit A General Conditions

- 1. This proposal is valid for 30 days from the date submitted.
- 2. This proposal is contingent upon reaching mutually agreeable contract terms, with the understanding that all proposal terms and these General Conditions shall be incorporated into any resulting contract between the parties.
- 3. Any resulting contract will create an independent contractor relationship between the parties; no fiduciary duty or agency will be created.
- 4. In the event of any conflicts among the contract documents, Contractor's Scope of Work and any conditions or exclusions therefrom shall control.
- 5. Owner will obtain all permissions, permits, licenses, and inspections required for Contractor to perform the Work and shall pay all costs associated therewith, excluding only those licenses required to be held by Contractor to generally perform this type of work.
- 6. Owner will provide all plans, specifications, and other designs services required for the Work no design services are included in Contractor's Scope of Work unless explicitly provided in the proposal.
- 7. Owner will provide unlimited and unrestricted access to the site area(s) necessary for the Work.
- 8. Owner will locate and mark or move, as necessary, any permanent or temporary utility, whether active or abandoned, that may be affected by the Work.
- 9. If vessel access is a component of the Work, the waterway shall be of sufficient depth for the vessel's required draft at the time(s) Contractor requires access.
- 10. Contractor will not perform any containment, cleanup, or disposal of hazardous materials that (a) were preexisting at the Site or (b) if brought to the Site for the Project, were not released by Contractor. If Contractor
  encounters any hazardous materials at the site that have not been rendered harmless, Contractor shall
  immediately stop work in the affected area and report the condition to Owner. To the fullest extent permitted
  by law, Owner shall defend, indemnify, and hold harmless Contractor, its affiliates, officers, employees,
  directors, and agents from all claims, damages, losses, and expenses, included but not limited to attorneys'
  fees, arising out of or resulting from any pre-existing hazardous materials.
- 11. If Owner is providing any materials or equipment for Contractor's Work, they shall be provided at no cost to Contractor and shall meet the requirements of the Work, including applicable plans and specifications, without the need for any alteration or adjustment, and Contractor shall not be responsible for any defects therein, warranty thereto, or damage or loss thereto, except to the extent caused by Contractor or its lower tier contractors.
- 12. Contractor shall be entitled to rely on the accuracy, adequacy, and completeness of the information provided to it or authored by Owner or Owner's other contractors, including without limitation the plans and specifications, their compliance with applicable laws, codes, and standards, and any site data, including subsurface data, regardless of any disclaimer and regardless of when the information was provided to Contractor. Such information shall be incorporated into any resulting contract. Contractor shall not be required to independently verify the accuracy, adequacy, or completeness of such information, though Contractor shall promptly notify Owner of any deficiencies or discrepancies that it discovers therein. If any deficiency or discrepancy impacts the Work, it shall be addressed via change order.
- 13. Contractor shall perform the Work in one continuous, uninterrupted operation, 10\_ hours per day, 7\_ days a week, unless otherwise specifically provided in the proposal.
- 14. Contractor shall commence and proceed with the Work according to a mutually agreeable schedule, which shall be incorporated into any resulting contract and which Owner may modify via change order. This change order shall encompass all related price and time impacts to Contractor.
- 15. If Contractor is unable to maintain a continuous operation due to circumstances beyond its control, including as a result of Owner's or Owner's other contractors' delays or Owner's suspension of the Work, Owner shall pay Contractor its standby rate of \$\_\_tbd\_\_\_ per hour, unless otherwise specifically provided in the proposal.
- 16. If any delay/suspension not caused by Contractor exceeds ten consecutive working days, or twenty cumulative working days during the project, Contractor may, at its option, demobilize, to return at a future mutually agreeable date, at the cost of Owner.

- 17. Contractor will provide payment and performance bonds upon request at an additional cost. Contractor will not provide a letter of credit, nor will Contractor's owners or officers provide a personal guarantee.
- 18. Owner shall pay Contractor at least monthly for approved invoices, which shall include stored materials, within 30 days of submission, assuming Contractor has provided all reasonably requested prerequisites.
- 19. Owner shall not withhold any retention from its payments to Contractor.
- 20. Owner shall pay Contractor 100% of its price for mobilization upon completion thereof.
- 21. Late payments by either party shall bear interest at the same rate, which shall be 18% per annum, unless otherwise agreed.
- 22. If Owner has the right to deduct or offset any payment, Contractor shall have an equal right to do so.
- 23. Contractor may suspend Work if Owner fails to pay undisputed amounts when due and fails to cure the nonpayment within five business days from written notice thereof.
- 24. Statutory lien/bond claim waivers shall be used wherever required or available. If the Work is being performed in a state that does not have statutory lien/bond claim waivers required or available, the lien/bond claim waivers shall mirror California's statutory waivers.
- 25. Contractor's lien rights shall not be subordinated to any other claimant of Owner.
- 26. Contractor has performed a reasonable investigation of the site satisfying itself as to (1) the known and readily observable nature, location, and character of the site and the project, specifically including the surface conditions of the site and the surrounding area, and all structures and obstructions thereon, both natural and man-made, and any subsurface conditions disclosed in writing by Owner; (2) the nature, location, and character of the general area in which the project is located, including generally prevailing climatic conditions, labor supply, labor cost, equipment supply, and equipment cost; (3) the quality and quantity of all materials, supplies, tools, equipment, labor, and services necessary to complete the Work at the quoted price and according to the mutually agreed schedule; and (4) any requirements imposed by applicable laws and applicable permits, and Contractor shall not be entitled to any increase in the price or extension to the schedule for its failure to perform such a reasonable site investigation. Contractor's obligation to perform a reasonable site investigation shall not extend beyond the foregoing and Contractor specifically repudiates any obligation to assume the risk of (a) subsurface conditions not disclosed in writing by Owner, (b) differing site conditions, (c) abnormal weather conditions, or (d) delays not caused by Contractor, and Contractor shall be entitled to make a claim for an increase to the price and/or extension to the schedule caused thereby.
- 27. Contractor warrants that the Work shall be performed in a good and workmanlike manner, according to the plans and specifications, free from defects in design, material, and workmanship, and using new materials unless otherwise specified. Contractor specifically disclaims all other warranties implied by law, including the warranty of fitness for a particular purpose and warranty of merchantability, as well as any requirement to perform the Work according to Owner's intent.
- 28. The duration of Contractor's warranty shall not (a) for construction Work, exceed one year from the substantial completion date of its Work or (b) for dredging Work, exceed the date the area is surveyed for payment.
- 29. Contractor shall not bear the risk of loss for any loss or damage to the Work (a) caused by Owner, Owner's other contractors, any force majeure events, (b) covered by Owner's builder's risk policy, or, if not caused or covered by any of the foregoing, (c)(i) for construction Work, beyond the date of substantial completion or Owner's beneficial use (in whole or in part) of the Work, whichever occurs earlier, or (ii) for dredging Work, beyond the date the area is surveyed for payment.
- 30. The amount of liquidated damages to be assess for Contractor delays shall be negotiated and shall only apply to the extent Contractor and/or its lower tier contractors are responsible for causing the delay.
- 31. Contractor's liability and indemnity obligations for any property damage, physical injury, breach of contract, or other claim, loss, damage, or expense shall be proportional, to the extent of its or its lower tier contractors' acts or omissions. Contractor shall not be liable for Owner's or any other party's acts or omissions, whether active or passive, or be required to indemnity Owner or any other party for such. Owner shall have the same liability and indemnity obligations to Contractor.
- 32. Contractor's provision of insurance, including its primary response, additional insured endorsements, and waivers of subrogation, shall be limited to the extent of Contractor's proportional liability and indemnity obligations.

33. Contractor shall not be required to waive any rights available to it under the law unless equally applicable to and waived by Owner.

34. Except provisions for liquidated damages or damages that are a part of third-party claims that either Party has an obligation to indemnify the other Party from, neither party shall be liable to the other for indirect damages of any kind, including incidental, special, and consequential damages and encompassing, without limitation, loss of use, loss of profit, and loss of business opportunity.

35. Contractor may request a change order or pursue a claim against Owner for an increase to the price and/or extension to the schedule when Owner's or Owner's other contractors' acts or omissions, including delays, adversely affect Contractor's performance of the Work or otherwise cause damage, loss, or expense to Contractor.

36. Change orders, and any claimed accord and satisfaction associated therewith, shall encompass only the scope of the change order, not the entirety of the project performed up to the date of the change order.

37. Change order / claim notice deadlines shall not be less than ten business days from the date Contractor knew of the circumstance giving rise thereto.

38. A change order shall utilize the unit prices provided in the contract, if applicable. If no such unit price is applicable, the parties will negotiate to reach a mutually agreeable price for the work. If the parties are unable to reach an agreement, Contractor shall perform the work on a time and materials basis, plus a fee of twenty-four percent for all overhead and profit associated therewith.


39. Force majeure shall include labor, material, equipment, and lower tier contractor shortages due to any pandemic or epidemic, including COVID-19, and all abnormal climate conditions, which shall be defined as all precipitation days for the period of time in excess of the ten year average reported by the National Oceanic and Atmospheric Administration reporting station located closest to the Site. Contractor shall not be responsible for any delay damages and shall be entitled to make a claim for an increase to the price and/or an extension to the schedule if delayed as a result thereof.


40. Contractor shall be given the opportunity to cure any breach of contract or defect in the Work, which it shall commence and diligently continue within a minimum of ten business days from written notice thereof.

41. In the event of termination for default, Owner may take possession of Contractor's materials as well as equipment and tools specifically leased for the project. All equipment and tools owned or leased for non-project-related reasons by Contractor shall remain in the sole possession of Contractor.

42. In the event of termination for convenience, Contractor shall be paid (a) for mobilization, the Work completed to date, and demobilization, each at the rates provided, (b) reasonable costs of termination, and (c) twenty-four percent of those termination costs for overhead and profit.

## Exhibit B

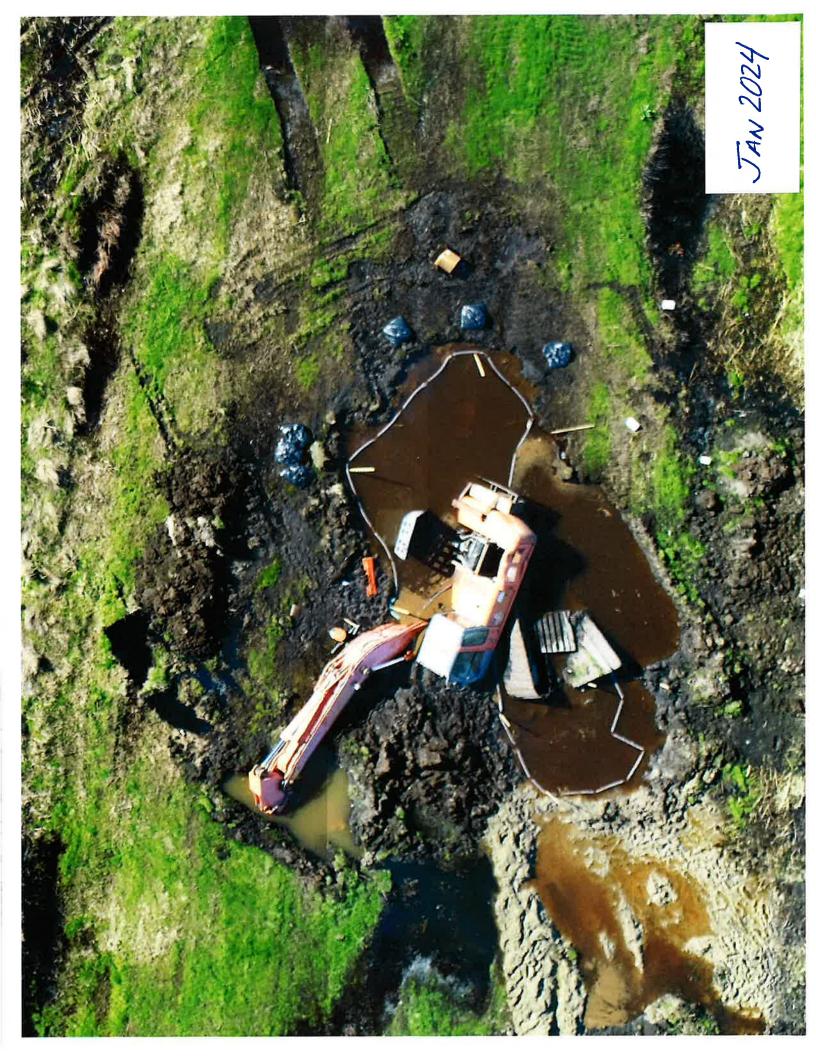

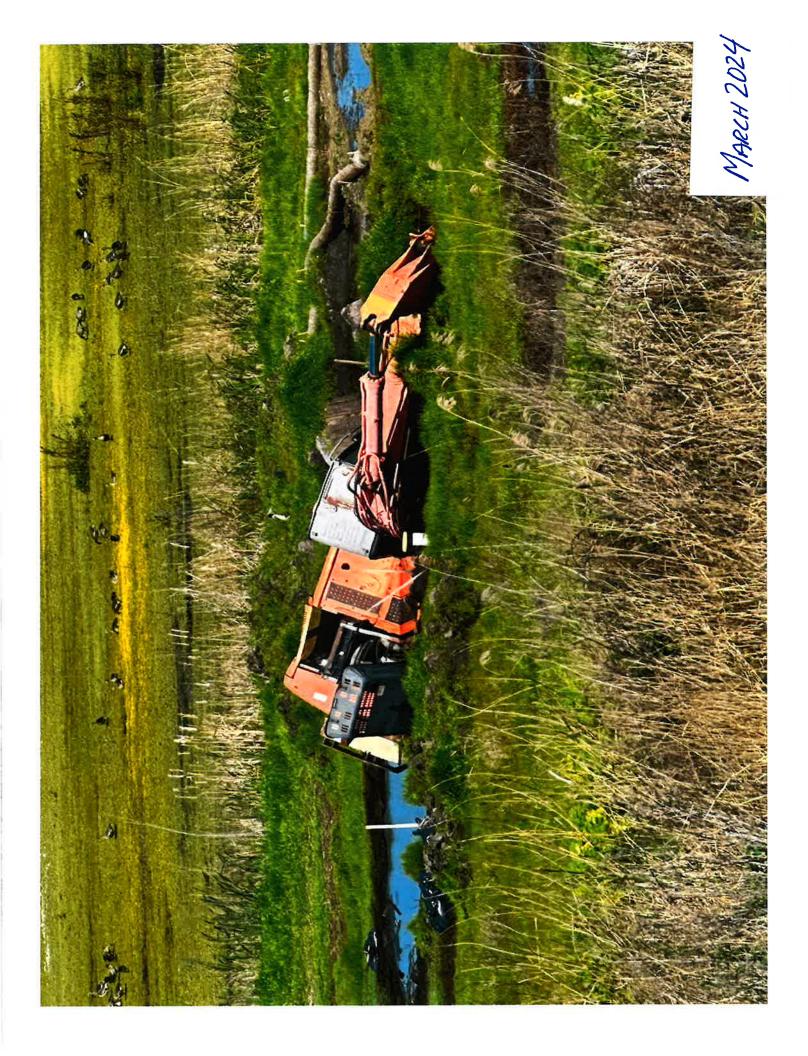

## Exhibit C

### RECLAMATION DISTRICT NO. 1601


### TWITCHELL ISLAND


SACRAMENTO COUNTY, CALIFORNIA

### **PUMP STATION SOLAR ARRAY**


BETWEEN

LEVEE STATION 510+00 AND STATION 515+00

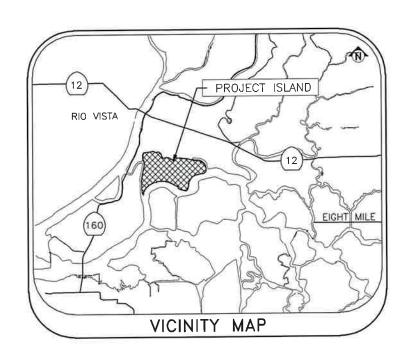

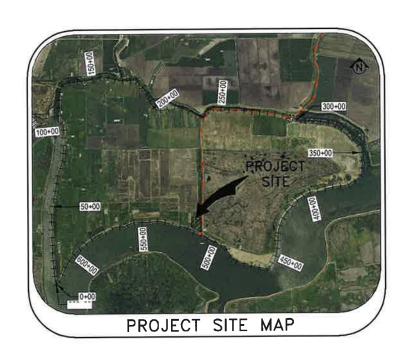

SHE	ET NO.	DESCRIPTION
	1	TITLE SHEET
	2	GENERAL NOTES
	3	BASE MAP & HAUL ROUTES
	4	SITE MAP
	5	FOOTING DETAILED PLAN VIEW
	6	STRUCTURAL COVER SHEET
	7-8	STRUCTURAL NOTES
	9	STRUCTURAL SITE PLAN
	10	CP1 STRUCTURAL VIEWS
	11	FOUNDATION DETAILS
	12	STEEL DETAILS
	13	ELECTRICAL PLAN
	14	SINGLE LINE DIAGRAM
		/
	SHE	ET INDEX

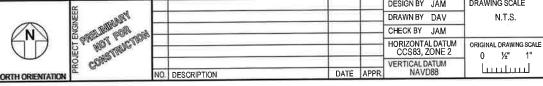



711 N Pershing Avenue Stockton, CA 95203

916-403-5900

TWITCHELL ISLAND SACRAMENTO COUNTY PUMP STATION SOLAR ARRAY TITLE SHEET

RECLAMATION DISTRICT 1601

	DATE	
	APRIL	2024
	SHEET IDEN	ITIFICATIO
٦	G-0	01
	SHEET 01	OF 05
	KSN PROJE	CT FILE NO
	1110	ODEO

### **GENERAL NOTES:**

- PRIOR TO THE COMMENCEMENT OF WORK, A JOINT INSPECTION BETWEEN THE ENGINEER, OR HIS REPRESENTATIVE, AND THE CONTRACTOR, OR HIS REPRESENTATIVE, WILL BE CONDUCTED TO REVIEW THE PRE-CONSTRUCTION CONDITIONS OF THE EXISTING FACILITIES IN THE VICINITY OF THE PROJECT SITE, (E.G. ROADS, PUMPS, DISCHARGE PIPES, SIPHONS, RAMPS, GATES, SIGNS, ETC.) F SLICH EXISTING FACILITIES ARE DAMAGED BY THE CONTRACTOR'S OPERATIONS, THE CONTRACTOR, AT HIS EXPENSE, SHALL REPLACE OR RESTORE THEM TO THE CONDITION THAT FXISTED PRIOR TO THE COMMENCEMENT OF WORK.
- THE CONTRACTOR SHALL NOTIFY THE ENGINEER AT (209) 946-0268. A MINIMUM OF 48 HOURS PRIOR TO THE COMMENCEMENT OF ANY WORK.
- THE DISTRICT RESERVES THE RIGHT TO SUSPEND CONSTRUCTION AT ANY TIME IN THE EVENT OF EXTREME HIGH OR LOW TIDES, FLOOD EVENTS, OTHER CONDITIONS OR EMERGENCIES THAT MAY JEOPARDIZE THE INTEGRITY OF THE DISTRICT'S LEVEE SYSTEM.
- THE CONTRACTOR SHALL COMPLY WITH ALL APPLICABLE FEDERAL, STATE, COUNTY AND LOCAL REQUIREMENTS, AS REQUIRED FOR TRAFFIC CONTROL AND PUBLIC SAFETY DURING PROJECT
- THE DISTRICT WILL FURNISH ALL RIGHT-OF- WAYS FOR ALL LEVEE ROADS UNDER THE DISTRICT'S JURISDICTION. THE CONTRACTOR WILL SECURE RIGHT-OF-WAYS FOR ALL OTHER AREAS NOT UNDER THE DISTRICT'S JURISDICTION.
- THE CONTRACTOR SHALL BE RESPONSIBLE FOR MAINTAINING ACCESS ALONG THE DISTRICT/COUNTY LEVEE ROADS AT ALL TIMES DURING CONSTRUCTION. ANY DAMAGE TO THE LEVEE ROADS AND ACCESS RAMPS SHALL BE IMMEDIATELY REPAIRED BY THE CONTRACTOR AT HIS EXPENSE.
- 7. IF DELIVERING MATERIAL OR EQUIPMENT BY TRUCK, ALL TRUCK TRAFFIC SHALL BE LIMITED TO THE DISTRICT/COUNTY LEVEE ROADS, UNLESS OTHERWISE APPROVED.
- MAXIMUM SPEED LIMIT ON DISTRICT LEVEE ROADS IS 30 MPH,
- THE ENGINEER WILL PROVIDE LOCATIONS OF THE DESIGNATED PROJECT SITE, AND WILL PROVIDE TEMPORARY BENCHMARKS IN THE VICINITY OF THE PROJECT SITES TO BE UTILIZED BY THE
- 10. THE CONTRACTOR IS RESPONSIBLE FOR SETTING ALL CONSTRUCTION STAKING AND SURVEYING, AS MAY BE REQUIRED FOR CONSTRUCTION ACTIVITIES.
- 11. CONTRACTOR AGREES THAT HE SHALL ASSUME SOLE AND COMPLETE RESPONSIBILITY FOR JOB SITE CONDITIONS DURING THE COURSE OF CONSTRUCTION OF THIS PROJECT, INCLUDING SAFETY OF ALL PERSONS AND PROPERTY; THAT THIS REQUIREMENT SHALL APPLY CONTINUOUSLY AND NOT BE LIMITED TO NORMAL WORKING HOURS; AND THAT THE CONTRACTOR SHALL DO NORMAL WORKING HOUSE, AND THE DISTRICT AND THE DISTRICT'S ENGINEER HARMLESS FROM ANY AND ALL LIABILITY, REAL OR ALLEGED, IN CONNECTION WITH THE PERFORMANCE OF WORK ON THIS PROJECT, EXCEPTING FOR LIABILITY ARISING FROM THE SOLE NEGLIGENCE OF THE DISTRICT OR THE ENGINEER.
- 12. ANY DEFICIENCIES NOTED DURING INTERIM AND FINAL INSPECTIONS BY THE ENGINEER AND/OR DISTRICT, SHALL BE CORRECTED BY THE CONTRACTOR PRIOR TO FINAL ACCEPTANCE BY THE DISTRICT. ANY ADDITIONAL COSTS AND EXPENSES FOR MOBILIZATION AND/OR DEMOBILIZATION, LABOR, EQUIPMENT AND OTHER ASSOCIATED COSTS REQUIRED TO CORRECT THE DEFICIENCIES NOTED, EXCEPT SPECIFIED MATERIAL(S), SHALL BE BORNE BY THE CONTRACTOR.
- 13. THE CONTRACTOR SHALL NOT CLOSE ANY ROAD, STREET, OR HIGHWAY TO THE PUBLIC EXCEPT WITH THE PERMISSION OF THE ENGINEER AND THE PROPER GOVERNMENTAL AUTHORITY. TEMPORARY PROVISIONS SHALL BE MADE BY THE CONTRACTOR TO ENSURE CONTINUOUS ACCESS TO PUBLIC AND PRIVATE DRIVEWAYS, AND PROPER FUNCTIONING OF SEWER INLETS, GUTTERS, CULVERTS, DRAINAGE AND IRRIGATION DITCHES, AND NATURAL WATER COURSES.
- 14. THE CONTRACTOR SHALL BE HELD RESPONSIBLE FOR ANY FIELD CHANGES MADE WITHOUT WRITTEN AUTHORIZATION FROM THE
- 15. SHOULD IT APPEAR THAT THE WORK TO BE DONE, OR ANY MATTER RELATIVE THERETO, IS NOT SUFFICIENTLY DETAILED OR EXPLAINED ON THESE PLANS, THE CONTRACTOR SHALL CONTRACT THE ENGINEER AT (209) 946-0288 FOR SUCH FURTHER EXPLANATIONS AS MAY BE NECESSARY.
- THE INTENT OF THESE PLANS ARE TO SERVE AS A GUIDE AND TO PROVIDE THE CONTRACTOR WITH INFORMATION AND DETAILS NECESSARY TO CONSTRUCT THE PROJECT AND FURNISH THE NECESSARY LABOR, MATERIALS, AND EQUIPMENT TO PERFORM THE WORK IN ACCORDANCE WITH THEIR TRUE INTENT AND PURPOSE. THE CONTRACTOR SHALL NOTIFY THE DISTRICTS ENGINEER IMMEDIATELY REGARDING ANY DISCREPANCIES AND AMBIGUITIES WHICH MAY EXIST IN THE PLANS OR SPECIFICATIONS. IF THE PLANS DESCRIBE PORTION OF THE WORK IN GENERAL TERMS BUT NOT IN COMPLETE DETAIL, IT IS UNDERSTOOD THAT ONLY THE BEST GENERAL PRACTICE IS TO PREVAIL AND THAT ONLY MATERIALS AND WORKMANSHIP OF THE FIRST QUALITY ARE TO BE USED.

- 17. ALL WORK SHALL BE PERFORMED IN ACCORDANCE WITH APPLICABLE OSHA REGULATIONS.
- 18. ALL IMPROVEMENTS TO BE DONE SHALL BE IN ACCORDANCE THE REQUIREMENTS OF THESE PLANS AND SPECIFICATIONS,
- 19. THE CONTRACTOR SHALL NOTIFY THE ENGINEER WHENEVER IT APPEARS THERE IS A CHANGE IN SITE CONDITIONS OR AN ADJUSTMENT TO BE MADE IN WORK REQUIREMENTS.
- 20. THE CONTRACTOR SHALL AT ALL TIMES BE RESPONSIBLE FOR THE SECURITY OF HIS PLANT AND EQUIPMENT. THE DISTRICT WILL NOT TAKE ANY RESPONSIBILITY FOR MISSING OR DAMAGED EQUIPMENT. TOOLS, OR PERSONAL BELONGINGS.

### ENVIRONMENTAL NOTES:

- THE CONTRACTOR SHALL MAINTAIN AIR POLLUTION CONTROLS BY NOT DISCHARGING SMOKE, DUST, OR ANY OTHER AIR
  CONTAMINANTS INTO THE ATMOSPHERE IN SUCH QUANTITY AS
  WILL VIOLATE THE REGULATIONS OF ANY LEGALLY CONSTITUTED
  AUTHORITY. HE SHALL ALSO ABATE DUST NUISANCE BY CLEANING, SWEEPING AND SPRINKLING WITH WATER, OR OTHER MEANS AS NECESSARY. THE USE OF WATER IN AN AMOUNT WHICH RESULTS IN MUD ON PUBLIC ROADS IS NOT ACCEPTABLE AS A SUBSTITUTE FOR SWEEPING OR OTHER METHODS.
- THE CONTRACTOR SHALL EXERCISE EVERY REASONABLE PRECAUTION TO PROTECT STREAMS, WATERWAYS AND OTHER BODIES OF WATER FROM POLLUTION WITH FUELS, OIL, BITUMEN'S, CALCIUM CHLORIDE, AND OTHER HARMFUL MATERIALS AND SHALL CONDUCT AND SCHEDULE HIS OPERATIONS SO AS TO AVOID OR MINIMIZE MUDDYING AND SILTING OF SAID WATERS. CARE SHALL BE EXERCISED TO PRESERVE ROADSIDE VECETATION BEYOND THE LIMITS OF CONSTRUCTION.
- THROUGHOUT ALL PHASES OF CONSTRUCTION, INCLUDING SUSPENSION OF WORK, AND UNTIL FINAL ACCEPTANCE OF THE PROJECT, THE CONTRACTOR SHALL KEEP THE WORK SITE CONDITIONS CLEAN AND FREE FROM RUBBISH AND
- 4. THE CONTRACTOR SHALL PRESERVE AND PROTECT ANY PLANTS AND TREES AS MAY BE DESIGNATED AND MARKED BY THE ENGINEER AT THOSE REPAIR SITES AND DESIGNATED PRIOR TO COMMENCEMENT OF SITE WORK. SOME PRUNING AND TRIMMING OF BRANCHES MAY BE REQUIRED.

### UTILITY NOTES:

- IT IS THE RESPONSIBILITY OF THE CONTRACTOR TO DETERMINE
  THE ACTUAL LOCATION OF ALL UNDERGROUND, SURFACE,
  OVERHEAD, AND SUBMARINE IMPROVEMENTS, OR FACILITIES WHICH MAY BE SUBJECT TO DAMAGE BY REASON OF HIS OPERATIONS.
- 2. THE CONTRACTOR SHALL VERIFY THE LOCATION OF ALL EXISTING UNDERGROUND UTILITIES AND SHALL CONTACT THE RESPECTIVE UTILITY COMPANIES PRIOR TO COMMENCEMENT OF WORK. HE SHALL BE RESPONSIBLE FOR THE LOCATION AND PRESERVATION OF ALL SUCH FACILITIES IN THE AREA OF CONSTRUCTION, AND SHALL NOTIFY UTILITIES TWENTY-FOUR (24) HOURS IN ADVANCE OF ANY CONSTRUCTION. (UNDERGROUND SERVICE ALERT (800) 642-2444).

### **DUST AND MUD CONTROL:**

- DURING THE COURSE OF CONSTRUCTION, THE CONTRACTOR SHALL KEEP ALL CONSTRUCTION AREAS, HAUL ROADS, OTHER ROADWAYS, AND OTHER USE AREAS WHERE DUST IS GENERATED WELL WATERED.
- THE CONTRACTOR MAY BE REQUIRED TO DEDICATE AT LEAST ONE (1) WATER TRUCK FOR THE ALLEVIATION OR PREVENTION OF DUST NUISANCE FOR, BUT NOT LIMITED TO, THE FOLLOWING
- ACCESS ROADS CROP AREAS
- LEVEE CROWN ROADS
- WATER WILL BE MADE AVAILABLE FOR THE CONSTRUCTION OPERATIONS FROM THE SURROUNDING WATERWAY. THE PUMPING FACILITY SHALL BE LOCATED IN AN AREA THAT WILL NOT CREATE A TRAFFIC OR MUD HAZARD ON THE ROADS USED BY THE CONTRACTOR, PUBLIC AND LOCAL TRAFFIC.

### ACCESS HAUL ROADS:

- THE CONTRACTOR SHALL IMPROVE AND MAINTAIN THE LEVEE ACCESS ROADS AS MAY BE REQUIRED ALONG THE ROUTES DESIGNATED ON THE PLANS TO TRANSPORT THE MATERIAL TO THE REPAIR SECTIONS.
- THE DESIGNATED LEVEE ACCESS ROUTES FOR THIS PROJECT MAY REQUIRE THE CONTRACTOR TO MODIFY AND REWORK THE EXISTING LEVEE ROADS TO MEET THE CONTRACTOR'S HAULING
- THE CONTRACTOR IS SOLELY RESPONSIBLE FOR MAKING ANY NECESSARY IMPROVEMENTS, MODIFICATIONS, AND ALTERATIONS TO MEET HIS REQUIREMENT AND FOR THE MAINTENANCE AND EXPENSE THEREOF.

- 4. THE CONTRACTOR SHALL SECURE ALL OTHER ACCESS ROAD EASEMENTS AS MAY BE REQUIRED WITH THE INDIVIDUAL PROPERTY OWNERS FOR ALL NON-DISTRICT AND/OR PUBLIC ACCESS ROADS AND AS DESCRIBED IN SPECIAL PROVISIONS, SECTION 1.12, "TRAFFIC CONTROL & RIGHT-OF-WAY.
- 5. THE CONTRACTOR SHALL BE RESTRICTED TO THE USE OF HIGHWAY LEGAL SIZED TRUCKS AND TRAILERS AND OTHER EQUIPMENT OPERATIONS OVER THE DESIGNATED ROADS, UNLESS OTHERWISE APPROVED BY THE ENGINEER.

### SPECIAL NOTES:

THE NOTES PLACED ON THIS PLAN SHEET ARE TO BE USED AS A GUIDE FOR VARIOUS TOPICS DESCRIBED. SPECIFIC DETAILS AND FURTHER EXPLANATIONS OF THE VARIOUS NOTES ARE DESCRIBED AT LENGTH IN THE SPECIFICATIONS AND WITHIN



DRAWING SCALE DESIGN BY JAM DRAWN BY DAV N.T.S. CHECK BY 1AM HORIZONTAL DATUM DRIGINAL DRAWING SCALE CCS83, 70NF 2 1/2" 0 VERTICAL DATUM DATE APPR NAVD88 NO. DESCRIPTION




Stockton, CA 95203 209-946-0268

West Sacramento, CA 95691 916-403-5900

RECLAMATION DISTRICT 1601 TWITCHELL ISLAND

PUMP STATION SOLAR ARRAY **NOTES & DETAILS** 

APRIL 2024 SHEET IDENTIFICATIO G-002 SHEET 02 OF 05 KSN PROJECT FILE NO 1110 - 0950

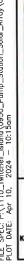





					DESIGN BY JAM	DRAWING SCALE
PRAIME					DRAWN BY DAV	1" = 1000'
AND ROS THE				_	CHECK BY JAM	
MOLL LANGLING.	$\vdash$				HORIZONTAL DATUM CCS83, ZONE 2	ORIGINAL DRAWING SCALE  0 1/2" 1"
Chem.	NO.	DESCRIPTION	DATE	APPR.	VERTICAL DATUM NAVD88	لسبلسنا
		0200		_		

KJELDSEN 711 N Pershing Avenue
Slockton, CA 95203
209-946-0268
NELDECK
CIVIL ENGINEERS & LAND SURVEYORS
West Sacramento, CA 95691
www.ksninc.com
916-403-5900

RECLAMATION DISTRICT 1601 TWITCHELL ISLAND SACRAMENTO COUNTY

PUMP STATION SOLAR ARRAY BASE MAP & HAUL ROUTES

DATE APRIL 2024 SHEET IDENTIFICATION CS-101 SHEET 03 OF 05 KSN PROJECT FILE NO. 1110 - 0950





1000			_
THE PROPERTY.			
PROTES TON			
Wall Supplement			_
Co.,	NO.	DESCRIPTION	-
	NO.	DESCRIPTION	

DRAWN BY DAV CHECK BY JAM HORIZONTAL DATUM CCS83, ZONE 2 ORIGINAL DRAWING SCALE 0 ½" 1" VERTICAL DATUM NAVD88 لتسلسيا

KJELDSEN 711 N Pershing Avenue Stockton, CA 95203 209-946-0268

NEUDECK 1550 Harbor Drive, Suite 212 West Sacramento, CA 95891 916-403-5900

RECLAMATION DISTRICT 1601 TWITCHELL ISLAND SACRAMENTO COUNTY

PUMP STATION SOLAR ARRAY SITE MAP

DATE APRIL 2024 SHEET IDENTIFICATION

C-101

SHEET 04 OF 05

KSN PROJECT FILE NO.
1110 - 0950



NO. DESCRIPTION


DRAWN BY DAV 1" = 20' CHECK BY JAM HORIZONTAL DATUM CCS83, ZONE 2 ORIGINAL DRAWING SCALE 0 ½" 1" VERTICAL DATUM NAVD88 لتتبلليتنا

SINNOCK NEUDECK
CIVIL ENGINEERS & LAND SURVEYORS
West Sacramento, CA 95691
www.ksninc.com
916-403-5900

SACRAMENTO COUNTY

PUMP STATION SOLAR ARRAY FOOTING DETAILED PLAN VIEW

SHEET IDENTIFICATION C-102 SHEET 05 OF 05 KSN PROJECT FILE NO. 1110 - 0950

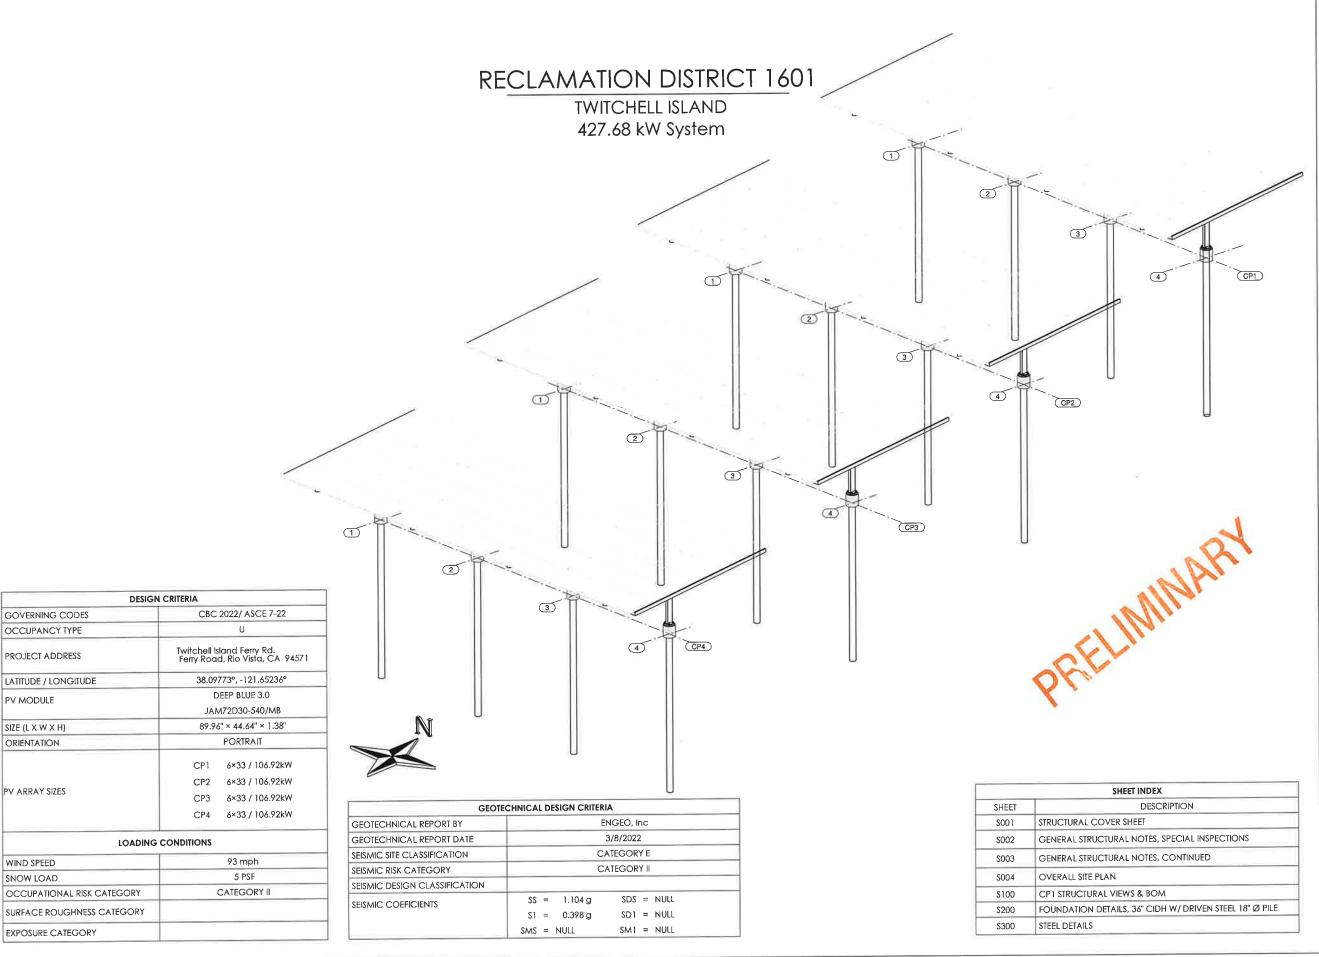



627 WILLIAMS ST., BAKERSFIELD, CA 93305 USA +1 (661) 912-0560

PROPRIETARY NOTICE:
THIS DRAWING CONTAINS CONFIDENTIAL
INFORMATION PROPRIETARY TO
KERN SOLAR STRUCTURES, INC.
REPRODUCTION, DISCLOSURE OR OTHER
UNAUTHORIZED USE IS STRICTLY PROHIBITED.
TAKE

RECLAMATION DISTRICT 1601
TWITCHELL ISLAND

DRAWN BY:
ACH
PROJECT ENGINEER:
M. GILLIS
PROJECT:
24410
DRAWNG FILE:
SOOI - COVER SHEET
PROJECT STEE, INJUN SPEC:
Galvanized to ASTM A 123
SURFACE PREP: SSPC-SP6 (U.N.O)
ODICINAL SHEET SUF SUR 242

**S001** 

PRINT DATE

### GENERAL STRUCTURAL NOTES

### GENERAL

- THE CONTRACTOR SHALL VERIFY ALL DIMENSIONS PRIOR TO STARTING
  CONSTRUCTION, DO NOT SCALE DRAWINGS.
- 2. THE STRUCTURAL ERECTION DRAWINGS AND SPECIFICATIONS REPRESENT THE FINISHED STRUCTURE, THEY DO NOT INDICATE THE METHODS OF CONSTRUCTION THE CONTRACTOR SHALL PROVIDE WHICH ARE REQUIRED TO PROTECT THE STRUCTURE DURING CONSTRUCTION, SUCH MEASURES MIGHT INCLUDE, BUT ARE NOT LIMITED TO BRACING AND SHORING.
- ALL REQUESTS FOR CLARIFICATION (RFC) MUST BE SUBMITTED IN WRITING PRIOR TO PROCEEDING WITH WORK.
- 4. THE ENGINEER OF RECORD SHALL BE NOTIFIED OF ANY DISCREPANCIES OR INCONSISTENCIES.
- 5. ALL DRAWINGS ARE CONSIDERED CONTRACT DOCUMENTS, THE CONTRACTOR SHALL BE RESPONSIBLE FOR THE REVIEW, CONTROL AND COORDINATION OF ALL DRAWINGS AND SPECIFICATIONS IN CONNECTION WITH PRE-CONSTRUCTION AND CONSTRUCTION ACTIVITIES.
- 6. ANY DISCREPANCIES SHALL BE BROUGHT TO THE ATTENTION OF KERN SOLAR STRUCTURES AND THE ENGINEER OF RECORD IN WRITING PRIOR TO THE INITIATION OF WORK, ALL DISCREPANCIES SHALL BE CLARIFIED IN WRITING BY KERN SOLAR STRUCTURES AND THE ENGINEER OF RECORD PRIOR TO THE CONTINUATION OF WORK.
- 7. ANY WORK PERFORMED IN CONFLICT WITH THE CONTRACT DOCUMENTS OR ANY CODE OR STANDARD REQUIREMENTS SHALL BE CORRECTED BY THE CONTRACTOR AT THEIR EXPENSE.
- 8. NOTES AND DETAILS ON APPLICATION / PROJECT SPECIFIC DRAWINGS SHALL TAKE PRECEDENCE OVER GENERAL NOTES AND DETAILS.
- ALL WORK SHALL CONFORM TO THE MINIMUM STANDARDS INCLUDING THE FOLLOWING CODES: LOCAL BUILDING CODE, REGULATING AGENCIES, AUTHORITY HAVING JURISDICTION (AHJ)

### CONTRACTOR SUBMITTALS AND SHOP DRAWINGS

- THE CONTRACTOR SUBMITTALS AND SHOP DRAWING ARE INTENDED TO HELP THE STRUCTURAL ENGINEER OF RECORD VERIFY THE DESIGN CONCEPT, IT IS THE CONTRACTOR'S RESPONSIBILITY TO CHECK THEIR OWN SHOP DRAWINGS.
- THE STRUCTURAL SHOP DRAWINGS WILL BE RETURNED FOR RESUBMITTAL IF A
   CURSORY REVIEW SHOWS MAJOR ERRORS WHICH SHOULD HAVE BEEN
   ADDRESSED BY THE CONTRACTOR.
- THE FOLLOWING SUBMITTALS (ALONG WITH SUPPORTING CALCULATIONS)
  ARE REQUIRED FOR STRUCTURAL REVIEW:
  - A. REINFORCING STEEL DESIGN INCLUDING FABRICATION DRAWINGS
  - B. CONCRETE MIX DESIGN INCLUDING STRENGTH TEST RESULTS
     C. STRUCTURAL STEEL FABRICATION DRAWINGS
- 4. THE FOLLOWING SUBMITTALS TYPICALLY ARE NOT REQUIRED FOR
- STRUCTURAL REVIEW:
- A. FORMWORK

  B. STRUCTURAL STEEL MILL REPORTS
- C. SHORING AND BRACING
- 5. SHOP DRAWINGS AND CALCULATIONS SHALL CLEARLY REFERENCE THE DESIGN ASSUMPTIONS USED TO PRODUCE THE SUBMITTAL.
- ALL SUBMITTALS WILL BE PROVIDED IN A DIGITAL FORMAT FOR REVIEW
   (PREFERABLY PDF) BY THE STRUCTURAL ENGINEER OF RECORD.

### STATEMENT OF STRUCTURAL TESTS AND SPECIAL INSPECTIONS

THE FOLLOWING ELEMENTS OF CONSTRUCTION SHALL REQUIRE SPECIAL INSPECTION PER CHAPTER 17 OF THE CURRENT BUILDING CODE UNLESS NOTED OTHERWISE

SPECIAL INSPECTIONS AND TESTING SHALL BE PROVIDED BY AN INSPECTION AGENCY, EMPLOYED BY THE OWNER, AND QUALIFIED BY THE BUILDING OFFICIAL TO INSPECT THE PARTICULAR TYPE OF CONSTRUCTION, TESTS AND INSPECTIONS, AS REQUIRED BY SECTIONS 110 & 1705 OF THE CURRENT IBC, SHALL BE PERFORMED DURING CONSTRUCTION ON THE TYPES OF WORK LISTED BELOW:

CATEGORY	INSPECTION	TESTING
STRUCTURAL STEEL CONSTRUCTION	SECTION 1705.2	SECTION 1705,13
CONCRETE CONSTRUCTION	SECTION 1705.3 / TABLE 1705.3	SECTION 1705,3
• SOILS	SECTION 1705 6 / TABLE 1705 6	
CAST-IN-PLACE DEEP FOUNDATIONS	SECTION 1705.8 / TABLE 1705.8	

- A. THE SPECIAL INSPECTIONS IDENTIFIED ON PLANS ARE, IN ADDITION TO, AND NOT A SUBSTITUTE FOR, THOSE INSPECTIONS REQUIRED TO BE PERFORMED BY THE GOVERNING JURISDICTION, SPECIALLY INSPECTED WORK WHICH IS INSTALLED OR COVERED WITHOUT THE APPROVAL OF AN INSPECTOR FROM THE GOVERNING JURISDICTION IS SUBJECT TO REMOVAL OR EXPOSURE.
- B. FOR CONTINUOUS INSPECTION, WHEN WORK IN MORE THAN ONE CATEGORY OF WORK REQUIRING SPECIAL INSPECTION IS TO BE PERFORMED SIMULTANEOUSLY, OR THE GEOGRAPHIC LOCATION OF THE WORK IS SUCH THAT IT CANNOT BE CONTINUOUSLY OBSERVED IN ACCORDANCE WITH THE PROVISIONS OF THE CODE, IT IS THE CONTRACTOR'S RESPONSIBILITY TO EMPLOY A SUFFICIENT NUMBER OF INSPECTORS TO ASSURE THAT ALL WORK IS INSPECTED IN ACCORDANCE WITH THOSE PROVISIONS.
- C. THE SPECIAL INSPECTORS MUST BE CERTIFIED BY THE GOVERNING JURISDICTION IN THE CATEGORY OF WORK REQUIRED TO HAVE SPECIAL INSPECTION.
- EXCEPTIONS:

  1. SOILS INSPECTIONS BY THE SOILS ENGINEER OF RECORD OR THE PROJECT INSPECTOR
- 2. WHEN WAIVED BY THE GOVERNING JURISDICTION
- D. IT IS THE RESPONSIBILITY OF THE CONTRACTOR TO INFORM THE SPECIAL INSPECTOR OR INSPECTION AGENCY AT LEAST TWO WORKING DAYS PRIOR TO PERFORMING ANY WORK THAT REQUIRES SPECIAL INSPECTION, ALL WORK PERFORMED WITHOUT REQUIRED SPECIAL INSPECTION IS SUBJECT TO REMOVAL.
- E. PROVIDE SPECIAL INSPECTION FOR CONNECTIONS BOLTED WITH A 325 AND A 490 BOLTS, INSPECTIONS SHALL BE DONE PER APPROVED NATIONALLY RECOGNIZED STANDARDS AND THE REQUIREMENTS OF THE CODE AND THE GOVERNING JURISDICTION, WHILE THE WORK IS IN PROGRESS, THE SPECIAL INSPECTOR SHALL DETERMINE THE BOLTS, NUTS, WASHERS AND PAINT; BOLTED PARTS; AND INSTALLATION AND TIGHTENING MEET THE STANDARDS REQUIREMENTS,
- F. THE SPECIAL INSPECTOR FOR HIGH STRENGTH BOLTED CONNECTIONS SHALL:
- OBSERVE THE CALIBRATION PROCEDURES WHEN SUCH PROCEDURES ARE REQUIRED BY THE PLANS OR SPECIFICATIONS.
- 2. MONITOR THE INSTALLATION OF BOLTS TO DETERMINE THAT ALL PLIES OF CONNECTED MATERIALS HAVE BEEN DRAWN TOGETHER.
- 3. MONITOR THAT THE SELECTED PROCEDURE IS PROPERLY USED TO TIGHTEN ALL BOLTS.
- G. THE CONSTRUCTION MATERIALS TESTING LABORATORY MUST BE APPROVED BY THE GOVERNING JURISDICTION. FOR TESTING OF MATERIALS, SYSTEMS, COMPONENTS AND, EQUIPMENT.
- H. PERIODIC INSPECTION SHALL OCCUR FREQUENTLY ENOUGH TO INSPECT ALL OF THE INSTALLED ITEMS AND TO PERIODICALLY WITNESS THE INSTALLATION OF THE ITEMS.
- PERIODICALLY WINNESS HE INSTALLATION OF THE TIEMS.

  1. THE SPECIAL INSPECTOR SHALL PROVIDE WEEKLY REPORTS AND A FINAL REPORT TO THE STRUCTURAL ENGINEER IN ADDITION TO REPORTING REQUIREMENTS QUILINED IN SECTION 1704.2.4.
- J. A CERTIFICATE OF SATISFACTORY COMPLETION OF WORK REQUIRING SPECIAL INSPECTION MUST BE COMPLETED AND SUBMITTED TO THE GOVERNING JURISDICTION AND THE STRUCTURAL ENGINEER OF RECORD FOR THE PROJECT.
- K. THE SPECIAL INSPECTOR SHALL ENSURE THAT ALL DEFICIENCIES NOTED BY THE STRUCTURAL ENGINEER IN STRUCTURAL OBSERVATION REPORTS ARE CORRECTED, SUCH COMPLIANCE SHALL BE REFERENCED IN SPECIAL INSPECTOR REPORT.

### STRUCTURAL STEEL

1. STRUCTURAL STEEL DESIGN SHALL BE APPROVED AND FABRICATED BY AN AISC APPROVED CONTRACTOR.

2. ALL STRUCTURAL STEEL SHALL CONFORM TO THE ASTM DESIGNATION INDICATED BELOW UNLESS OTHERWISE NOTED:

DESCRIPTION	DESIGNATION
W SHAPES - COLUMNS, GIRDERS AND BEAMS	A992, GRADE 50
BASE PLATES AND CAP PLATES	A572, GRADE 50
STIFFENERS AND MISC. PLATES	A572, GRADE 50 OR A36
ANGLES, CHANNELS AND MISC.	A36
HSS SECTIONS	A500, GRADE C
'C' AND 'Z' PURLINS	A 653-G90
	BOLTS: ASTM A325
	NUTS: ASTM A563
HIGH STRENGTH BOLTED CONNECTIONS	WASHERS: F436
	TC BOLTS: F1852
	TI WASHERS: F959
ANCHOR RODS	F1554, GRADE 105

- THE STRUCTURAL STEEL FABRICATOR SHALL MAINTAIN ALL MANUFACTURERS MATERIAL TEST REPORTS (MTR) FOR ALL STRUCTURAL STEEL MEMBERS.
- 4. THE APPROVED STRUCTURAL STEEL FABRICATOR SHALL EMPLOY DETAILED FABRICATION AND QUALITY CONTROL PROCEDURES THAT PROVIDE A BASIS FOR INSPECTION CONTROL OF THE WORKMANSHIP AND MATERIALS USED IN FABRICATION, AT COMPLETION OF FABRICATION, THE APPROVED FABRICATOR SHALL SUBMIT A CERTIFICATE OF COMPLIANCE TO THE BUILDING OFFICIAL STATING THAT THE WORK WAS PERFORMED IN ACCORDANCE WITH THE APPROVED CONSTRUCTION DOCUMENTS.
- ALL STRUCTURAL STEEL MEMBERS SHALL BE CLASSIFIED AS ARCHITECTURALLY EXPOSED STRUCTURAL STEEL TYPE 3 (AESS 3)
  AND SHALL BE FABRICATED, FINISHED AND HANDLED PER ANSI/ AISC 303-16, CHAPTER 10-AESS 3.
- 6. ALL WELDING TO BE PERFORMED BY WELDERS CERTIFIED TO AWS D1.1 STRUCTURAL WELDING CODE, PER AISC 360 LATEST EDITIONS AND APPROVED WELD PROCEDURES.
- 7. ALL WELDING FILLER MATERIALS SHALL BE APPROVED TO AWS SPECIFICATION A5.20 AND CLASSIFIED TO AWS E71T-1.
- 8. STRUCTURAL OBSERVATIONS SPECIFIED IN SECTIONS 1, 2 AND 3 OF THE ADJACENT TABLE (STEEL: TESTS AND SPECIAL INSPECTIONS) ARE NOT REQUIRED FOR THIS PROJECT PER BUILDING CODE IF FABRICATION IS COMPLETED BY A FABRICATOR APPROVED TO PERFORM SUCH WORK WITHOUT SPECIAL INSPECTION.
- 9. AT COMPLETION OF FABRICATION, THE APPROVED FABRICATOR SHALL SUBMIT A CERTIFICATE OF COMPLIANCE TO THE OWNER OR OWNER'S AUTHORIZED AGENT FOR SUBMITTAL TO THE BUILDING OFFICIAL STATING THAT WORK WAS PERFORMED IN ACCORDANCE WITH THE APPROVED CONSTRUCTION DOCUMENTS.
- 10. ALL HIGH STRENGTH BOLTS SHALL BE TIGHTENED TO "PRETENSIONED" CONDITION PER AISC 360 SECTION J3.2b AND RCSC SPECIFICATION SECTION B.2 UNLESS OTHERWISE SPECIFIED.
- 11. ALL EXPOSED STEEL MEMBERS, HARWARE AND BOLTS SHALL BE GALVANIZED OR OTHERWISE TREATED PER APPROVED LOCAL STANDARDS TO RESIST CORROSION.

STEEL: TESTS AND SPECIAL INSPECTIONS			
VERIFICATION AND INSPECTION	TYPE	RESP	REFERENCING STANDARD
1. VERIFICATION OF STRUCTURAL STEEL MATERIAL			
A. STRUCTURAL STEEL MARKINGS CONFORMING TO AISC 360, CURRENT EDITION	Р	SI	AISC 360: M5.5
B. VERIFY MANUFACTURERS MATERIAL TEST REPORTS	Р	SI	AISC 360: M5.5
2. VERIFICATION OF WELD FILLER MATERIALS AND PROCEDURES			
A. VERIFY MARKINGS TO CONFORM TO INDICATED AWS SPECIFICATION	Р	SI	AISC 360: A3.5 AWS A5.20
B. VERIFY MANUFACTURERS MATERIAL TEST REPORTS OR CERTIFICATE OF COMPLIANCE	Р	12	AISC 360: A3.5 AWS A5.20
C. VERIFY WELD PROCEDURE (WPS), WELDER QUALIFICATION AND EQUIPMENT	Р	SI	AISC 360: A3.5 AWS A5.20
3. VERIFICATION OF WELDING			
A. MULTIPASS WELDS	С	SI	AWS D1.1
B. SINGLE-PASS WELDS > 5/16"	С	SI	AWS D1,1
C. SINGLE PASS WELDS = 5/16"	Р	SI	AWS D1.1
4. MATERIAL VERIFICATION OF HIGH-STRENGTH BOLTS, NUTS AND WASHERS			
A. IDENTIFICATION MARKINGS TO CONFORM TO ASTM STANDARDS	Р	SI	AISC 360: A3.3, N5.6-1 RCSC 2.3
B. VERIFY MANUFACTURERS MATERIAL TEST REPORTS OR CERTIFICATE OF COMPLIANCE	Р	SI	AISC 360: N5.6-1 RCSC 2.1
C. VERIFY "SNUG-TIGHTEND" CONNECTIONS	Р	SI	AISC 360: M2 5, N5 6-2 RCSC 8 1, 9 1

### TEST AND SPECIAL INSPECTIONS KEY

TYPE:

- P (PERIODIC) INDICATES THAT A PERIODIC SPECIAL INSPECTION IS REQUIRED C (CONTINUOUS) INDICATES THAT A CONTINUOUS SPECIAL INSPECTION IS
- REQUIRED
- T (TEST) INDICATES THAT A TEST IS REQUIRED
- RESPONSIBILITY (PERFORMED BY):
- \$1 (SPECIAL INSPECTOR) INDICATES THAT A SPECIAL INSPECTION IS TO BE PERFORMED BY QUALIFIED SPECIAL INSPECTOR
- PI (PROJECT INSPECTOR) INDICATES THAT A SPECIAL INSPECTION IS TO BE PERFORMED BY THE QUALIFIED PROJECT INSPECTOR
- GE (GEOTECHNICAL ENGINEER) INDICATES THAT THE SPECIAL INSPECTION IS TO BE PERFORMED BY A REGISTERED GEOTECHNICAL ENGINEER OR HIS/ HER AUTHORIZED REPRESENTATIVE



627 WILLIAMS ST. BAKERSFIELD, CA 93305 USA +1 (661) 912-0560

PROPRIETARY NOTICE:
THIS DRAWNING CONTIDENTIAL
INFORMATION PROPRIETARY TO
KERN SOLAR STRUCTURES, INC.
REPROQUECTION, DISCLOSURE OR OTHER
UNAUTHORIZED USE IS STRICTLY PROHIBITED.

RECLAMATION DISTRICT 1601
TWITCHELL ISLAND

427.68 kW System

A ESTED FOR SIMPL REVENT
B SSIED FOR SIMPLE AND FEBRIT
B SSIED FOR SIMPLE AND FEBRIT AND FEBRIT

DRAWN BY:
ACH
PROJECT ENGINE

M. GILLIS

24410 DRAWING FLE

S002- GENERAL STRUCTURAL NOTES

PROJECT STEEL FINISH SPEC:
Galvanized to ASTM A123
SURFACE PREP: SSPC-SP6 (U.N.O.)

ORIGINAL SHEET SIZE 36 X 24 DO NOT SCALE DRAWING

5002

PRINT DATE

### GENERAL STRUCTURAL NOTES CONTINUED

### FOUNDATION

- CONTRACTOR SHALL INVESTIGATE SITE DURING CLEARING AND EARTHWORK OPERATIONS FOR FILLED EXCAVATIONS OR BURIED STRUCTURES, SUCH AS CESSPOOLS, CISTERNS, FOUNDATIONS, ETC. IF ANY SUCH STRUCTURES ARE FOUND, STRUCTURAL ENGINEER SHALL BE NOTIFIED IMMEDIATELY.
- CONTRACTOR SHALL REMOVE CONTAMINATED SOILS (WHERE OCCUR) PER THE SOILS REPORT, SOIL REMOVAL AND RECOMPACTION SHALL BE PER THE SOILS REPORT AND APPROVED CONTRACT DOCUMENTS.
- 3. FOUNDATIONS SHALL BE PLACED AND ESTIMATED ACCORDING TO DEPTHS SHOWN ON DRAWINGS, SHOULD SOIL ENCOUNTERED AT THESE DEPTHS NOT BE APPROVED BY THE INSPECTOR OR SOILS ENGINEER, FOUNDATION ELEVATIONS WILL BE ALTERED.
- 4. KEEP EXCAVATIONS FREE OF WATER BEFORE PLACING CONCRETE UNLESS OTHERWISE APPROVED BY THE SOILS ENGINEER, IF UNABLE TO SEAL OFF WATER FLOW, PER THE APPROVAL OF THE SOILS ENGINEER, ALLOW WATER LEVEL TO ATTAIN ITS NORMAL LEVEL AND PLACE CONCRETE BY THE TREMIE METHOD OR OTHER APPROVED METHOD, CONTRACTOR TO PROVIDE FOR DE-WATERING OF EXCAVATIONS FROM EITHER SURFACE WATER, GROUND WATER, OR SEEPAGE, IF REQUIRED,
- 5. EACH BORING FOR THE DRILLED PIER MUST BE INSPECTED BY THE SOILS ENGINEER PRIOR TO PLACING CONCRETE AND REINFORCING STEEL, ADJUST SHAFT LENGTHS UNDER DIRECTION OF THE SOILS ENGINEER AND THE OWNER'S REPRESENTATIVE BASED ON SOIL CONDITIONS AT TIME OF DRILLING.
- 6. PRECAUTIONS SHOULD BE TAKEN DURING THE INSTALLATION OF PIERS TO MINIMIZE THE POSSIBILITY OF CAVING, CLOSELY SPACED PIERS SHOULD BE DRILLED AND FILLED ALTERNATELY, ALLOWING THE CONCRETE TO SET AT LEAST EIGHT HOURS BEFORE DRILLING AN ADJACENT HOLE. PIER EXCAVATIONS SHOULD BE FILLED WITH CONCRETE AS SOON AFTER DRILLING AND INSPECTION AS POSSIBLE.
- 7. PLACE REINFORCING STEEL IN ONE CONTINUOUS UNIT AND ACCURATELY HOLD SECURELY IN FINAL POSITION USING CHAIRS OR SPACERS DURING CONCRETE PLACEMENT.
- 8. AN UNREINFORCED HEIGHT OF 12 INCHES AT THE BOTTOM OF THE SHAFT IS ACCEPTABLE.
- 9. CONSTRUCTION SHALL COMPLY WITH THE REQUIREMENTS OF ACI 336,3R, LATEST EDITION.
- EXISTING SOILS PARAMETERS OUTLINED IN ENCLOSED GEOTECHNICAL DATA REPORT, PREPARED BY ENGEO, 7/21/21
- 11. THIS DESIGN IS BASED ON THE FINDINGS AND RECOMMENDATIONS OUTLINED IN ENCLOSED GEOTECHNICAL DESIGN REPORT, PREPARED BY ENGEO, 3/8/2022 GEOTECHNICAL DESIGN CRITERIA BASED ON THIS REPORT CAN BE FOUND ON \$001,

### REINFORCING STEE

- 1. REINFORCING BARS SHALL CONFORM TO THE REQUIREMENTS OF CHAPTER 19 OF THE CODE, ASTM A615 (A706 WHERE NOTED ON PLANS), GRADE 60 UNLESS OTHERWISE NOTED, DEFORMATIONS SHALL BE IN ACCORDANCE WITH ASTM A-305.
- 2. BARS SHALL BE CLEAN OF RUST, GREASE, OR OTHER MATERIALS LIKELY TO IMPAIR BOND, ALL REINFORCING BAR BENDS SHALL BE MADE COLD.
- 3. REINFORCING BARS SHALL NOT BE SPLICED UNLESS SPECIFICALLY NOTED ON PLAN AND SHALL CONFORM TO THE PROVISIONS OF ACI 318, LAP ALL HORIZONTAL BARS AT CORNERS AND INTERSECTIONS.
- 4. ALL BARS SHALL BE MARKED SO THEIR IDENTIFICATION CAN BE MADE WHEN THE FINAL IN-PLACE INSPECTION IS
- 5. REINFORCING STEEL SHALL BE DETAILED IN ACCORDANCE WITH ACI 315.
- 6. COMPLETE AND DETAILED REINFORCING PLACEMENT DRAWINGS SHALL BE PREPARED AND SUBMITTED FOR REVIEW BY THE STRUCTURAL ENGINEER PRIOR TO FABRICATION IN ACCORDANCE WITH SPECIFICATIONS AND APPLICABLE CODES, THESE APPROVED DRAWINGS SHALL BE AVAILABLE ON THE JOB SITE PRIOR TO PLACING OF CONCRETE.
- 7. REBAR SPACINGS GIVEN ARE MAXIMUM ON CENTER WHETHER STATED AS "O.C." OR NOT. UNLESS A SPECIFIED LENGTH IS GIVEN, ALL REBAR IS CONTINUOUS WHETHER STATED AS "CONT." OR NOT.
- 8. MILL TEST REPORTS FOR GRADE 60 BARDS SHALL BE SUBMITTED PRIOR TO PLACEMENT OF CONCRETE.
- 9. MECHANICAL BAR SPLICES (COUPLERS) SHALL BE USED WHERE SPECIFIED ON PLANS, THEY MAY ALSO BE USED AT THE CONTRACTOR'S OPTION IN LIEU OF LAP SPLICES AND WHERE REINFORCING IS SHOWN CONTINUOUS THROUGH BY ACI 318 AND BE ONE OF THOSE LISTED BELOW AND INSTALLED PER THE MANUFACTURER'S RECOMMENDATIONS:
- A. HRC 500 SERIES MECHANICAL COUPLERS (ICC ESR-2764)
- B. LENTON A2 SERIES MECHANICAL SPLICES (IAPMO ER-0129)

FOUNDATION TESTS AND SPECIAL INSPECTION	N\$			
VERIFICATION AND INSPECTION	TYPE	RESP	REFERENCING STANDARD	
1. SOILS (TABLE 1705.6)				
A. VERIFY MATERIALS BELOW FOOTINGS ARE ADEQUATE TO ACHIEVE	Р	GE	125	
THE DESIGN BEARING CAPACITY				
B. VERIFY EXCAVATIONS ARE EXTENDED TO PROPER DEPTH AND HAVE	Р	GE	(6)	
REACHED PROPER MATERIAL	·	-		
C. PRIOR TO PLACEMENT OF COMPACTED FILL, INSPECT SUBGRADE	Р	GE		
ADN VERIFY THAT SITE HAS BE PREPARED PROPERLY				
2. CAST-IN-PLACE DEEP FOUNDATIONS (TABLE 1705.8)				
A. INSPECT DRILLING OPERATIONS AND MAINTAIN COMPLETE AND	С	SI		
ACCURATE RECORDS FOR EACH ELEMENT.		01,		
B. VERIFY PLACEMENT LOCATIONS, PLUMBNESS, DIAMETER AND		SI		
DEPTH, VERIFY ADEQUATE END-BEARING STRATA CAPACITY AND	С		*	
PROPER MATERIAL AT DEPTH.				
3. REINFORCING STEEL (TABLE 1705.3)				
INSPECT REINFORCING STEEL, PRESTRESSING TENDONS, SHEAR	Р	SI	ACI 318: 20, 25.2, 25.3	
STUDS AND PLACEMENT		31	26.6.1 - 26.6.3	
B. INSPECT WELDABILITY OF REINFORCING STEEL OTHER THAN ASTM	Р	P SI	ACI 318: 20, 25.2, 25.3	
A706		31	26.6.1 - 26.6.3	
C. INSPECT ANCHOR BOLTS AND EMBED PLATES TO BE INSTALLED IN	С	SI	ACI 318: 17.8.2	
CONCRETE PRIOR TO AND DURING PLACEMENT OF CONCRETE	"	31	ACIGIO. 17.0.2	

### CONCRETE

- ALL CONCRETE CONSTRUCTION SHALL CONFORM WITH THE CODE AND WITH THE PROVISIONS OF ACI 318
  AND ACI 301.
- CONCRETE MIXES SHALL BE DESIGNED BY A QUALIFIED TESTING LABORATORY AND APPROVED BY THE STRUCTURAL ENGINEER.
- A. MIX DESIGN METHODS (TEST HISTORY OR TRIAL BATCH METHOD) PER THE CODE SHALL BE USED TO PROPORTION CONCRETE, SUBMIT MIX DESIGN METHOD DATA.
- B. MIX DESIGNS SHALL SATISFY EITHER THE SHRINKAGE CRITERIA OR THE W/ C RATIO AND TOTAL WATER CRITERIA.
- 3. PORTLAND CEMENT SHALL CONFORM TO ASTM C-150 TYPE II
- 4. AGGREGATE FOR HARD ROCK CONCRETE SHALL CONFORM TO ALL REQUIREMENTS AND TESTS OF ASTM C33 AND PROJECT SPECIFICATIONS, CONCRETE SHALL BE DESIGNED TO FACILITATE PLACEMENT BY PUMP, EXCEPTIONS MAY BE USED ONLY WITH PERMISSION OF THE STRUCTURAL ENGINEER.
- 5. CONCRETE MIXING OPERATION, ETC., SHALL CONFORM TO ASTM C94,
- 6. SCHEDULE OF STRUCTURAL CONCRETE PERFORMANCE REQUIREMENTS:

MEMBER	fc / 28 DAY	MAX W/C	MAX DENSITY
ALL FOOTINGS AND FOUNDATIONS	5000 PSI	0,50	150 PCF

- 7. PLACEMENT OF CONCRETE SHALL CONFORM TO ACI 301 AND PROJECT SPECIFICATIONS, CLEAN AND ROUGHEN TO 1/4" AMPLITUDE ALL CONCRETE SURFACES AGAINST WHICH NEW CONCRETE IS TO BE PLACED.
- 8. CONTINUOUS INSPECTION OF CONCRETE SHALL INCLUDE INSPECTION DURING INSTALLATION OF REINFORCING STEEL, INSPECTION SHALL BE SCHEDULED SO THAT PLACEMENT OF REINFORCING STEEL, CONDUIT, SLEEVES, AND EMBEDDED ITEMS MAY BE CORRECTED PRIOR TO PLACEMENT OF OVERLYING GRIDS OF REINFORCING STEEL.
- 9. FOR CAST-IN-PLACE CONCRETE, THE FOLLOWING MINIMUM CONCRETE COVER SHALL BE PROVIDED FOR REINFORCEMENT:

DESCRIPTION	MINIMUM COVER
CONCRETE CAST AGAINST AND PERMANENTLY EXPOSED TO EARTH	3" (±3/8")
CONCRETE EXPOSED TO EARTH OR WEATHER No., 6 THROUGH No., 18 BAR	2" (±36")
CONCRETE EXPOSED TO EARTH OR WEATHER No. 5 BAR, W31 OR D31 WIRE OR SMALLER	1 ½" (±3/8")
CONCRETE NOT EXPOSED TO WEATHER OR IN CONTACT WITH THE GROUND	3/4" ( ±1/4")

- 10. ALL REINFORCING BARS, ANCHOR BOLTS, AND OTHER CONCRETE INSERTS SHALL BE WELL SECURED IN POSITION PRIOR TO PLACING CONCRETE.
- 11. CONCRETE SHALL BE PUMPED IN PLACE IN 18" TO 24" LIFTS PER ACI RECOMMENDATIONS.
- 12. PIPES OR CONDUITS LARGER THAN 4" DIAMETER SHALL NOT BE EMBEDDED IN STRUCTURAL CONCRETE EXCEPT WHERE SPECIFICALLY APPROVED BY STRUCTURAL ENGINEER, PIPES OR CONDUITS SHALL NOT DISPLACE OR INTERRUPT REINFORCING BARS, SPACE THE PIPES OR CONDUITS SUCH THAT PROPER CONCRETE PLACEMENT AND CONSOLIDATION IS ACHIEVED.
- 13. FOAM USED AS STAY-IN-PLACE FORMS SHALL HAVE A MINIMUM COMPRESSIVE STRENGTH OF 5.8 PSI AT 1% DEFORMATION AND A MINIMUM MODULUS OF 580 PSI PER ASTM D6817.
- 14. PROVIDE MIN 1/4" CHAMFER ON ALL EXPOSED CORNERS UNLESS INDICATED OTHERWISE.

CONCRETE: TESTS AND SPECIAL INSPECTION  VERIFICATION AND INSPECTION	TYPE	RESP	REFERENCING STANDARD
I. PRE-PLACEMENT INSPECTIONS (TABLE 1705.3)			
A. INSPECT POSITION AND PLACEMENT OF REINFORCEMENT STEEL	С	SI	ACI 318: 26.6
B. INSPECT POSITION OF PLACEMENT OF EMBEDDED STRUCTURAL			ACI 318: 26.8.2.
STEEL COLUMNS, ANCHOR BOLT ASSEMBLIES, ELECTRICAL	С	SI	26,11,1,2
CONDUIT AND GROUNDING GRID EMBEDMENTS			6, 272
C. INSPECT FORMWORK FOR SHAPE, LOCATION AND DIMENSIONS	С	SI	ACI 318: 26.11.1.2
. CONCRETE PLACEMENT			
A. VERIFY USE OF REQUIRED DESIGN MIX	Р	SI	ACI 318: 19, 26,4.3. 26,4.4
B. INSPECT CONCRETE PLACEMENT TECHNIQUES	С	S1	ACI 318: 26.5
C. AT THE TIME CONCRETE IS SAMPLED TO FABRICATE SPECIMENS FOR STRENGTH TESTS, RECORD THE FOLLOWING TEST RESULTS OF THE CONCRETE: • SLUMP • AIR CONTENT • TEMPERATURE	С	St	ACI 318: 26.5, 26, 12 ASTM C172 ASTM C31
D. VERIFY SPECIFIED CURING TEMPERATURE AND TECHNIQUES FOR PLACED CONCRETE	Р	SI	ACI 318: 26.5.3 26.5.5
E. VERIFY IN-SITE CONCRETE STRENGTH PRIOR TO THE REMOVAL OF FORMS AND SHORING SYSTEMS	Р	SI	ACI 318: 26.11.2



### TEST AND SPECIAL INSPECTIONS KEY

### TYPE:

- P (PERIODIC) INDICATES THAT A PERIODIC SPECIAL INSPECTION IS REQUIRED
- C (CONTINUOUS) INDICATES THAT A CONTINUOUS SPECIAL INSPECTION IS REQUIRED
- T (TEST) INDICATES THAT A TEST IS REQUIRED RESPONSIBILITY (PERFORMED BY):
- \$1 (SPECIAL INSPECTOR) INDICATES THAT A SPECIAL INSPECTION IS TO BE PERFORMED BY QUALIFIED SPECIAL INSPECTOR
- PI (PROJECT INSPECTOR) INDICATES THAT A SPECIAL INSPECTION IS TO BE PERFORMED BY THE QUALIFIED PROJECT INSPECTOR
- GE (GEOTECHNICAL ENGINEER) INDICATES THAT THE SPECIAL INSPECTION IS TO

  BE PERFORMED BY A REGISTERED GEOTECHNICAL ENGINEER OR HIS/ HER


  AUTHORIZED REPRESENTATIVE

627 WILLIAMS ST. BAKERSFIELD, CA 93305 USA +1 (661) 912-0560 ROPRETARY NOTICE
HS DRAWING CONTAINS CONFIDENTIAL
FORMATION PROPRETARY TO
EEN SOLAR STRUCTURES, INC.
EEN SOLAR STRUCTURES, INC.
EPRODUCTION, DISCLOSURE OR OTHER
NAUTHORIZED USE IS STRICTLY PROHIBITED
NAUTHORIZED USE IS STRICTLY PROHIBITED. RECLAMATION DISTRICT 1601 TWITCHELL ISLAND ACH PRO JECT ENGINEE M. GILLIS 24410 DRAWING FILE S003- GENERAL STRUCTURAL NOTES PROJECT STEEL FINISH SPEC Galvanized to ASTM A123 SURFACE PREP: SSPC-SP6 (U.N.O) ORIGINAL SHEET SIZE 36 X 24 DO NOT SCALE DRAWING

S003

PROT DATE



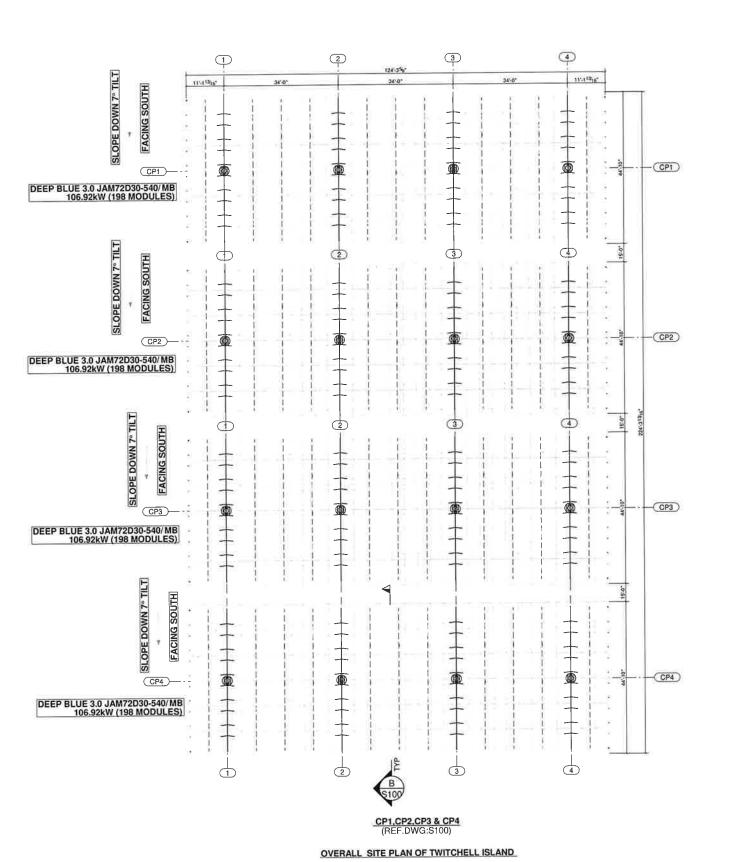

SOLAR

627 WILLIAMS ST. BAKERSFIELD, CA 93305 USA +1 (661) 912-0560

PROPRIETARY NOTICE:
THIS DRAWING CONTAINS CONFIDENTIAL
INFORMATION PROPRIETARY TO
KERN SOLAR STRUCTURES, INC.
KERN SOLAR STRUCTURES, INC.
KERN COLUCTION, DISCLOSURE OR OTHER
UNAUTHORIZED USE IS STRICTLY PROHIBITED.

RECLAMATION DISTRICT 1601
TWITCHELL ISLAND
427.68 kW system DB CB PKH ACH PKH ACH


DRAWN BY:


M. GILLIS


PROJEC1: 24410

\$004- OVERALL SITE PLAN
PROJECT STEEL FINISH SPEC:
Galvanized to ASTM A 123
SURFACE PREP: SSPC-SP6 (U.N.O) ORIGINAL SHEET SIZE 36 X 24 DO NOT SCALE DRAWING

**S004** 

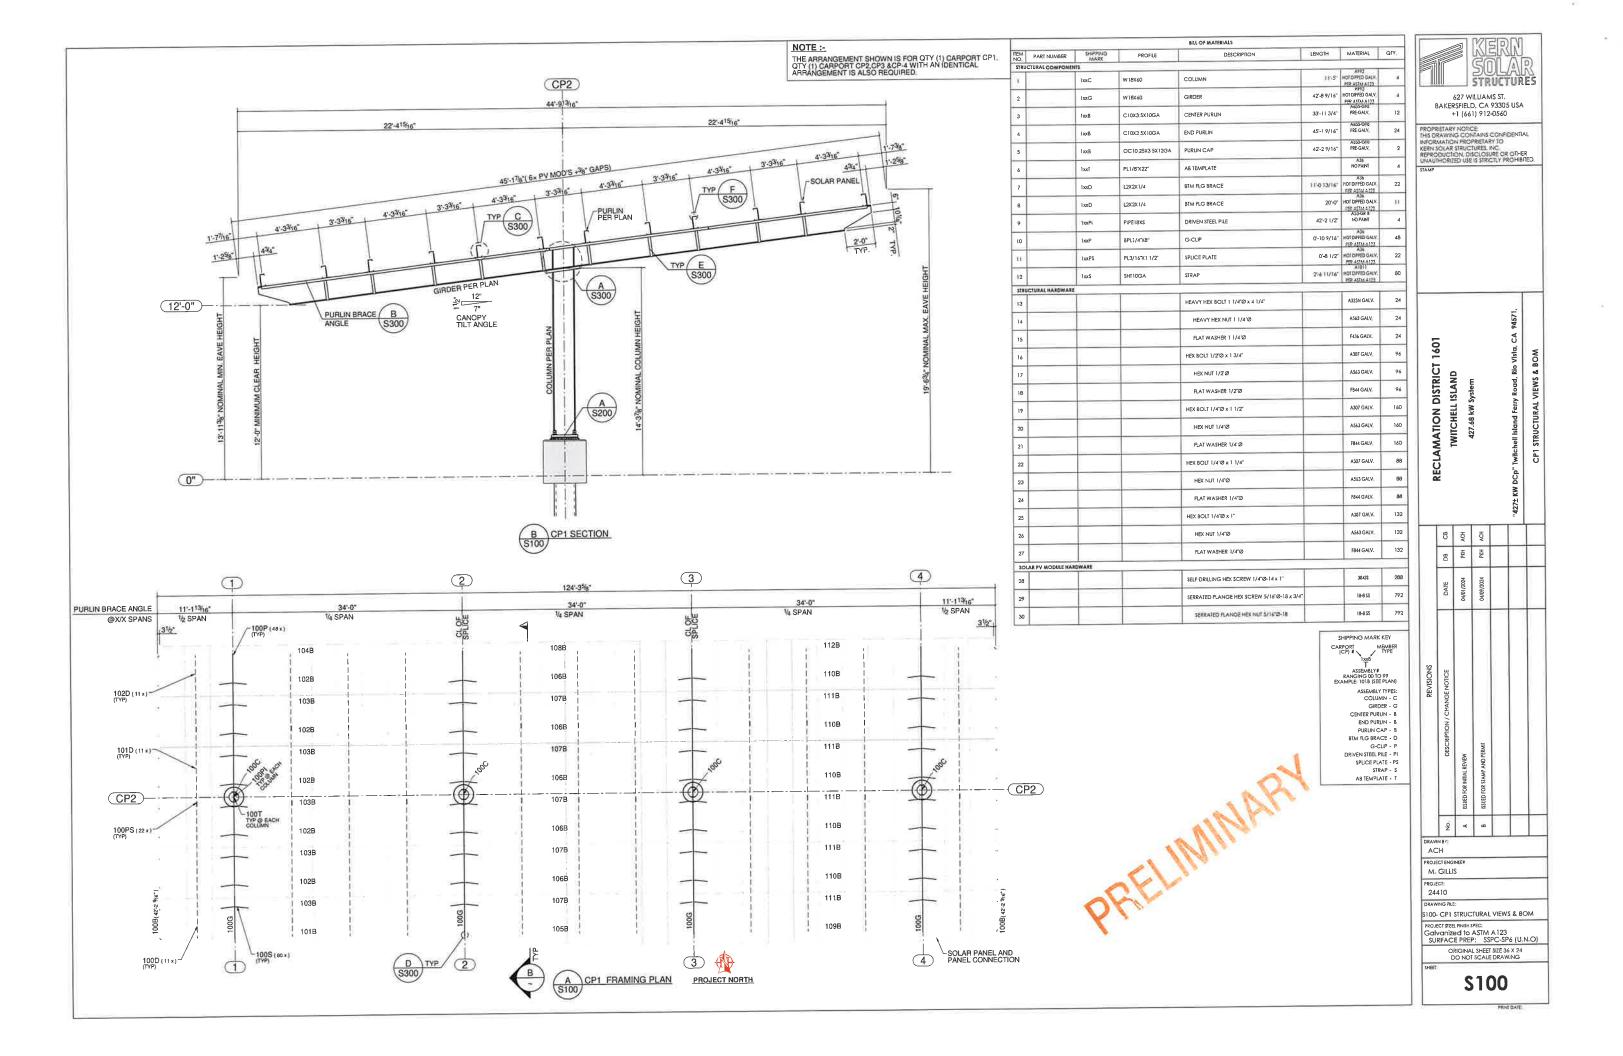

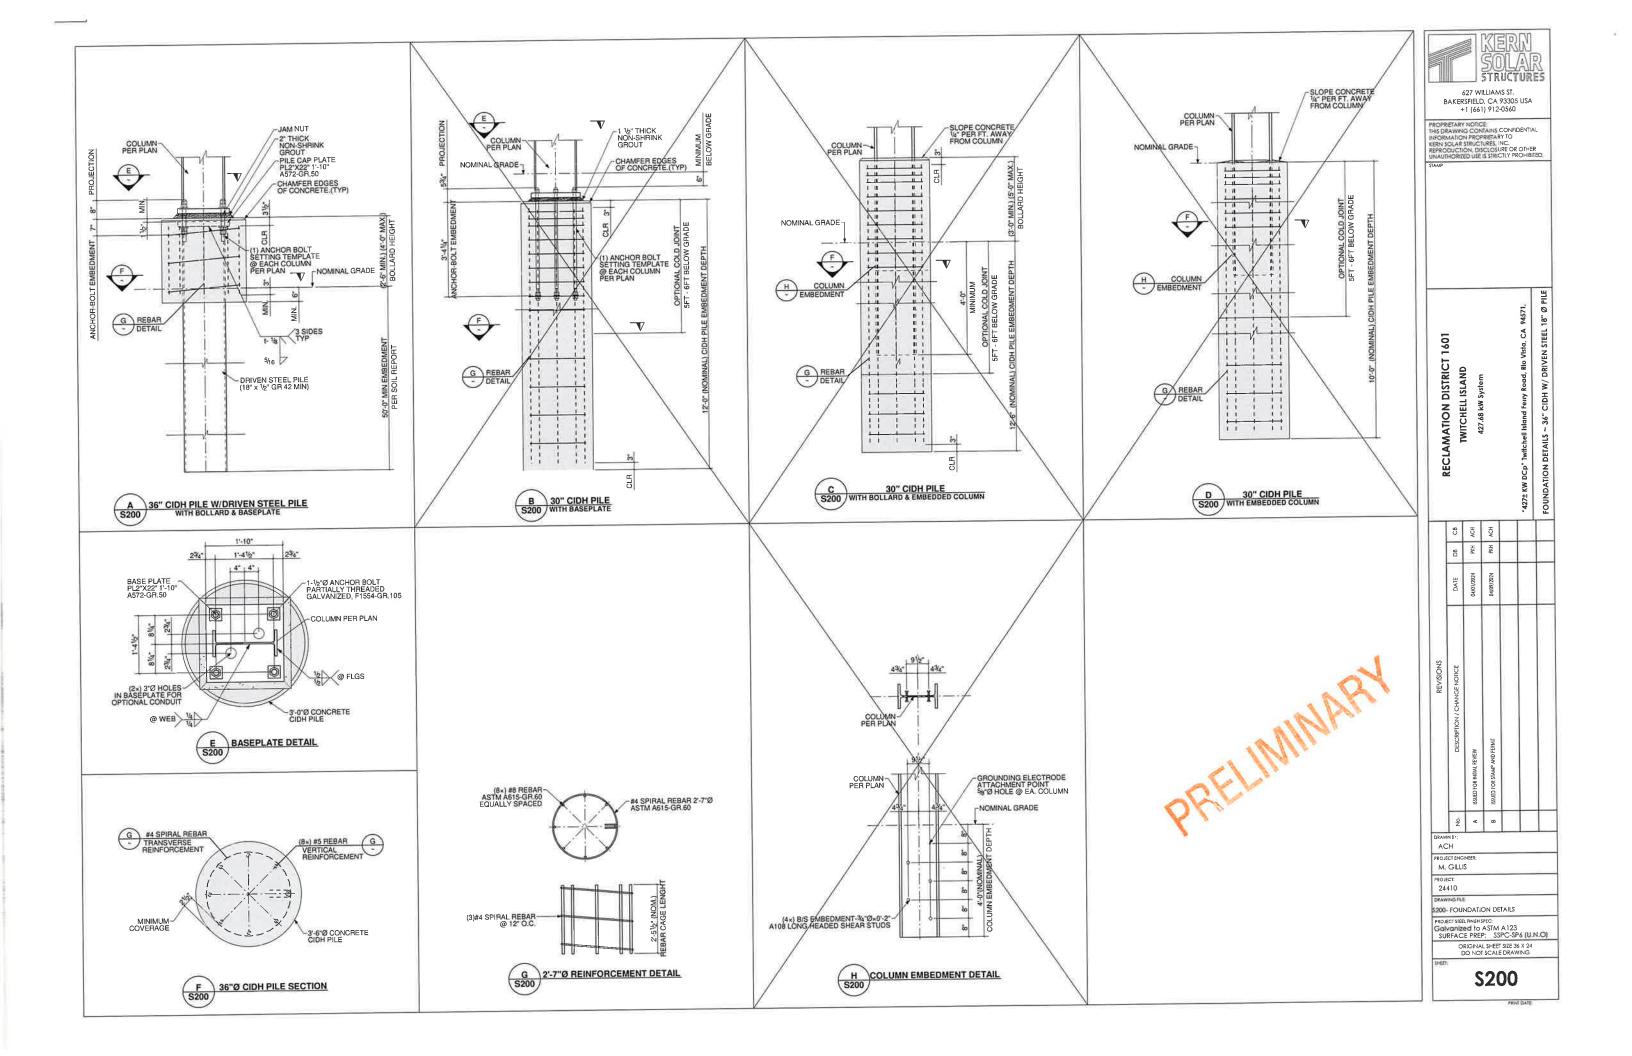

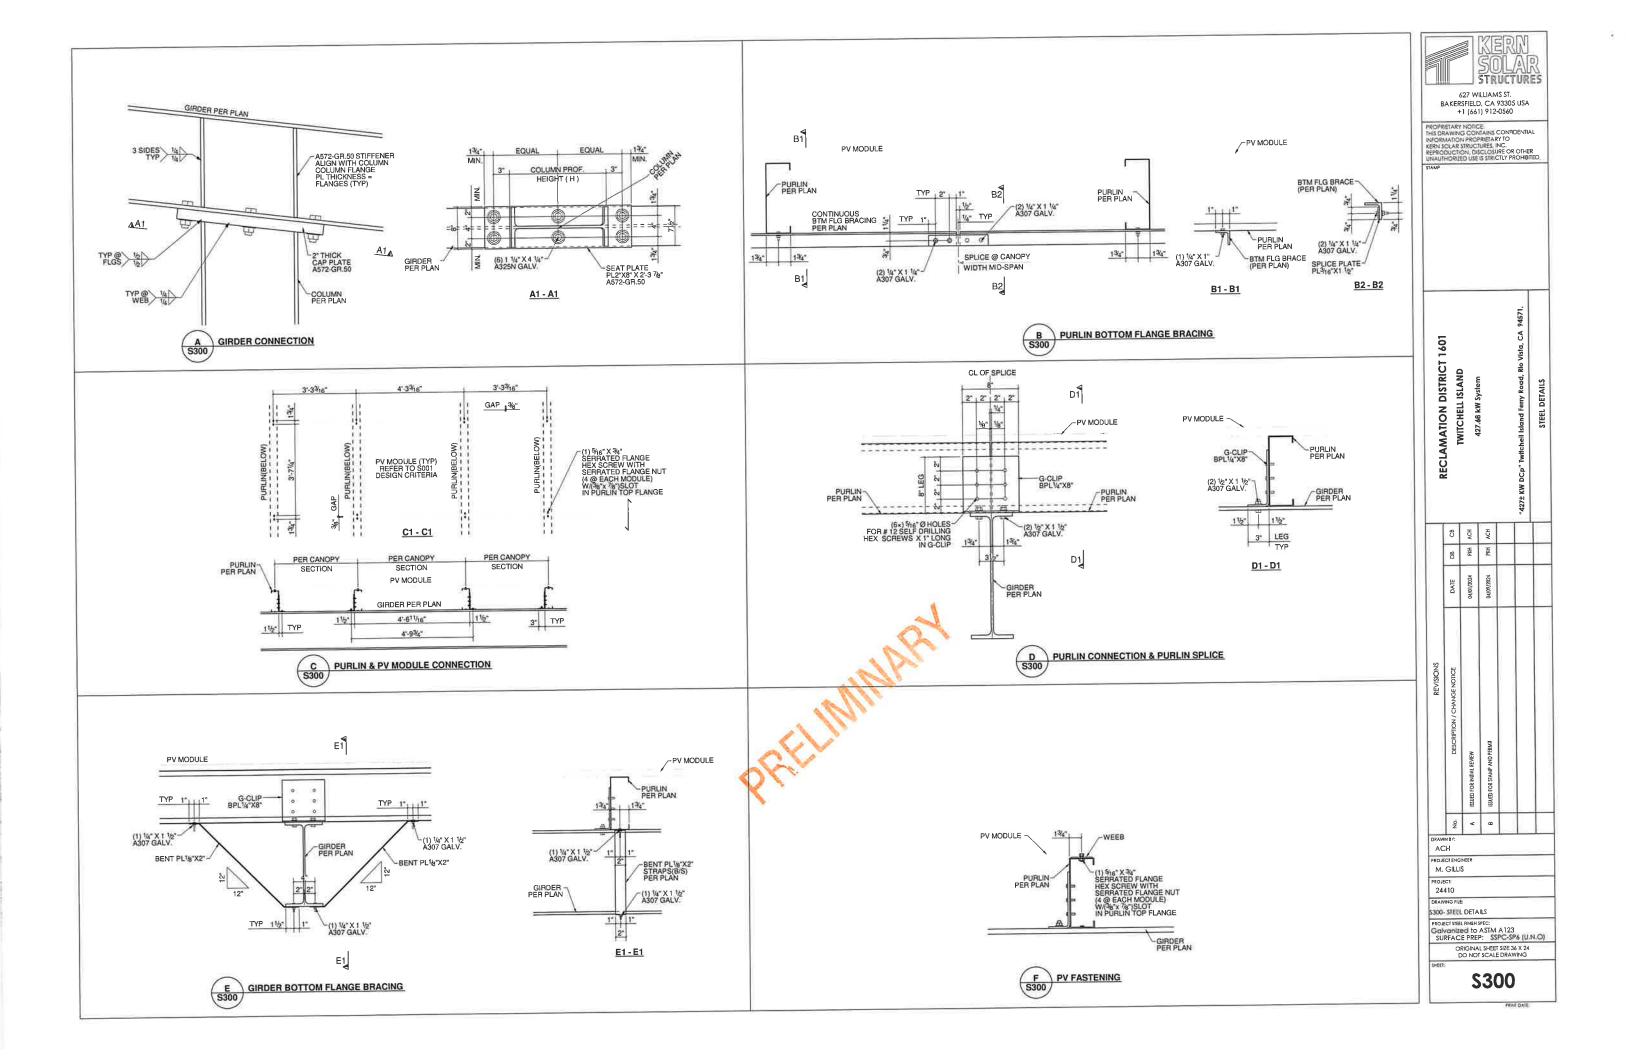

DWG DATE:

APPROVALS SENT DATE:

DRAWN BY: ESD

CHECKED BY: TP
SCALE: NONE

SCALE: NONE
FINAL PLANS DATE:
JOB:

SCALE: - 1" = 16'-0"

SHEET PV3 OF




SINGLE LINE DIAGRAM Job: DATE

APPROVALS SENT DATE: DRAWN BY: ESD снескео ву: ТР SCALE: NONE


SHEET PV4 OF

FINAL PLANS DATE: JOB:

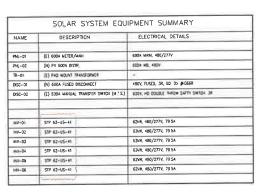

SOLAR SYST	EM ELEC	TRICAL SPECIFICATIONS	
DES	IGN TEMPER	ATURES (ASHRAE)	
MINIMUM DESIGN TEMPERATURE (°C)	1	MANUAL CESON TEMPERATURE (C)	24
	MODULE SE	PECIFICATIONS	
MAKE & MODEL (QUANTITY)		SILFAB SIL-490 HN (846)	
STC WATER (W)	490W	PTC RATING (W)	
OPEN CIRCUIT VOLTAGE (V)	53 96V	SHORT CIRCUIT CURRENT (A)	11 364
MAX POWER POINT VOLTAGE (V)	45 23V	MAX POWER POINT CURRENT (A)	10 83A
SERIES FUSE RATING (A)	30A	TEMPERATURE COEFFICIENT VOC	-0 275%/'0
NAX MODILES IN SERES	28	MAX. DC SYSTEM VOLTAGE (V)	1500V
	INVERTER S	PECIFICATIONS	
WAVE & WOOGL (QUANTITY)		SMA STP 82-US-41 (6)	
NOMINAL VOLTAGE (V)	480V	WAX. OUTPUT CURRENT	BOA

DO NOT CONNECT EITHER POLE OF THE DC CIRCUIT TO THE DC EQUIPMENT CROUNDING CONDUCTOR.

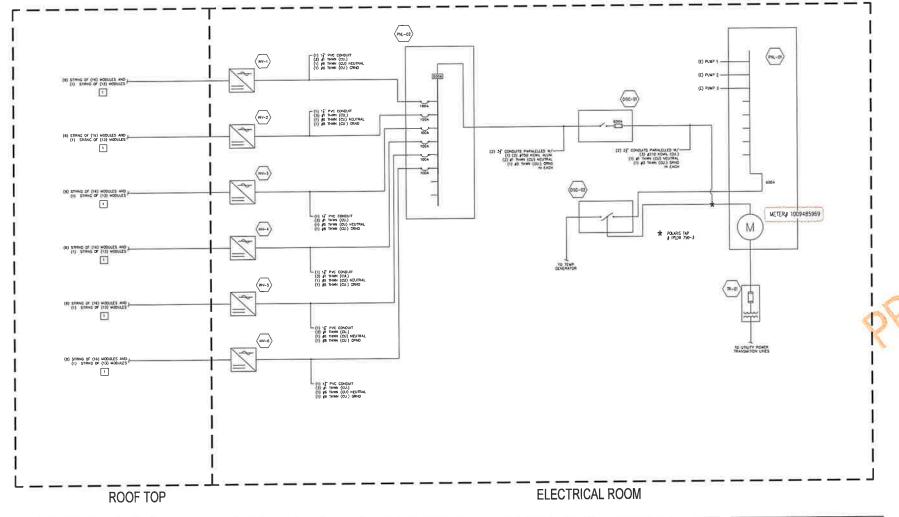

PV SIGNAGE

GRO-TIES PHOTOYOUTAK POWER SOURCE INVERTER OPERATING VOLTAGE SYSTEM VOLTAGE: COMEN INVESTER OUTPUT

SOLAR AC DISCONNECT
MAX OPERATING CURRENT,
OPERATING VOLTAGE:
4804

SOLAR RIPLIT BREAKER SOLAR DISCONNECT

THIS ELECTRICAL SYSTEM IS ALSO SERVICED BY A PHOTOVOLAIC SYSTEM VIA A LINE SIDE TAP

BASE NOTES AND EPEOPERATIONS
ALL ELECTRICAL SHALL BE INSTALLED IN COMPLIANCE WITH THE 2019
CE.C., ESC., C.P.C., AND CH.C.

CONSTIT.

1. ALL UNDERGROUND CONGUITS SHALL BE PIVE SCHEDULE 40. ALL
LINGERGROUND CONGUITS SHALL BE PIVE SCHEDULE 40. ALL
LINGERGROUND CONGUITS SHALL BE EXT. SHA 40 PIVE, OR LOUDD THAT REMBLE CONGUIT
ANY BE USED FOR PIVEL CORRECTIONS TO COOL-WELT
3. ALL LINGERGROUND CONGUITS TO HAVE WARNING TAPE 12' ABOVE 1. ALL CONDUCTORS SHALL BE THEN/THEN, COPPER UNLESS NOTED OTHERMS 2. ALL GROUNDED PY CONDUCTORS TO BE WHITE IN COLOR 3. 460Y HELITRIN, CONDUCTORS TO BE CRAY IN COLOR

ALL EQUIPMENT SHALL BE LISTED BY A MATCHALLY PICCOMED ASSAULT LABORATORY AND PROPERLY LABELED TO U. STANDARD CLEEN AND THE STANDARD CLEEN

SERIES STHINGS SHALL BE COMPRISED OF OTY. (13 OR 16) MODULES WRED IN SERIES SERIES CONNECTIONS TO BE MADE VIA MODULE QUICK CONNECTIS.

CONSCIST

2. ALL AC MIN DIC RODINGHIC CONDUCTORS SHALL CONNECT TO THE PREMISES DROUBLONG CLICIPODE SYSTEM

3. MINESTERS ARE COPPED WITH THE CAPACITY TO DETECT AND INTERRUPT DC. CROUND FAMILIS.

1. MIN DUES THAN OTH, (20) PT WESTS STRANG COPPET CONDUCTORS.

SHALL BE RINN WI THE SHALE CONDUCT AN ADDIT COMMOUNT FACEMAY.

LLL SIPPLOT COMPLOT IS U. LISTED

2 COUNDANT TO BE INSTALLED FOR LISTING ON LABELAGE AND

2 COUNDANT TO BE INSTALLED FOR LISTING ON LABELAGE AND

2 COUNDANT TO BE INSTALLED FOR LABELAGE AND

2 COUNDANT TO BE INSTALLED FOR LABELAGE

3 COUNTY TO BE INSTALLED FOR LABELAGE

5 ALL TITINGS USED OUTDOORS SHALL BE THE CARRENT LISTED

AND-THORT TOTAL

3 ALL THORY LISTED

AND-THORT TOTAL

3 ALL THORY LISTED

4 ALL THORY LISTED

5 AL

UTILITY NOTES.

1 INSTALLABOR SHALL HET ALL JAPANASES SAIETY AND PROFORMANCE SAIETY AND PROFORMANCE AS ALL AND WERE APPLICABLE, RALES OF THE PROF. FOR SAIL AND WERE APPLICABLE, RALES OF THE PROF. FOR SAIL AND WERE APPLICABLE, RALES OF THE PROF. FOR SAIL AND THE AUTHOR SAIL AND THE PROF. FOR SAIL AND THE AUTHOR SAIL PROPERTY AND THE AUTHOR SAIL PROF. FOR SAIL AND THE RESPONSIBLE FOR SAIL PROF. FOR SAIL AND THE CENTRAL BANK AND THE CENTRAL BANK AND THE CENTRAL BANK AND THE AUTHOR SAIL PROF. FOR SAIL AND THE AUTHOR SAIL PROF. FOR SAIL AND THE AUTHOR SAIL PROF. FOR SAIL PROF. FOR



## Exhibit D

## Christopher H. Neudeck

Howle, James F <jfhowle@usgs.gov>

From: Sent: To:

Friday, April 5, 2024 8:54 AM

Christopher H. Neudeck

Wong, Vincent@DWR USGS Study at Twitchell Island Levee

Twitch.png

Subject: Attachments: CAUTION: This email originated from outside the organization. Do not click links or open attachments unless you recognize the sender and know the content is safe.

Good Morning Chris,

My name is Jim Howle and I'm with the U.S. Geological Survey – California Water Science Center. Vincent Wong gave me your contact information and suggested that I contact you.

David Julian have identified a section of the Twitchell Island levee (highlighted area in the attachment) that would meet our science needs (a paved levee crest that is actively deforming). I was hoping that I could talk with you to discuss the possibility of the USGS conducting a validation study (using terrestrial lidar) in We are looking for a small study site to ground truth a new drone-mounted (UAV) levee monitoring technology (W-band InSAR). Vincent and DWR engineer this general area of the Twitchell Island levee.

Thank you for your time and consideration - Jim


Jim Howle – Hydrologist

**USGS California Water Science Center** 

Truckee Field Office

10775 Pioneer Trail, Suite 102

Truckee, CA. 96161

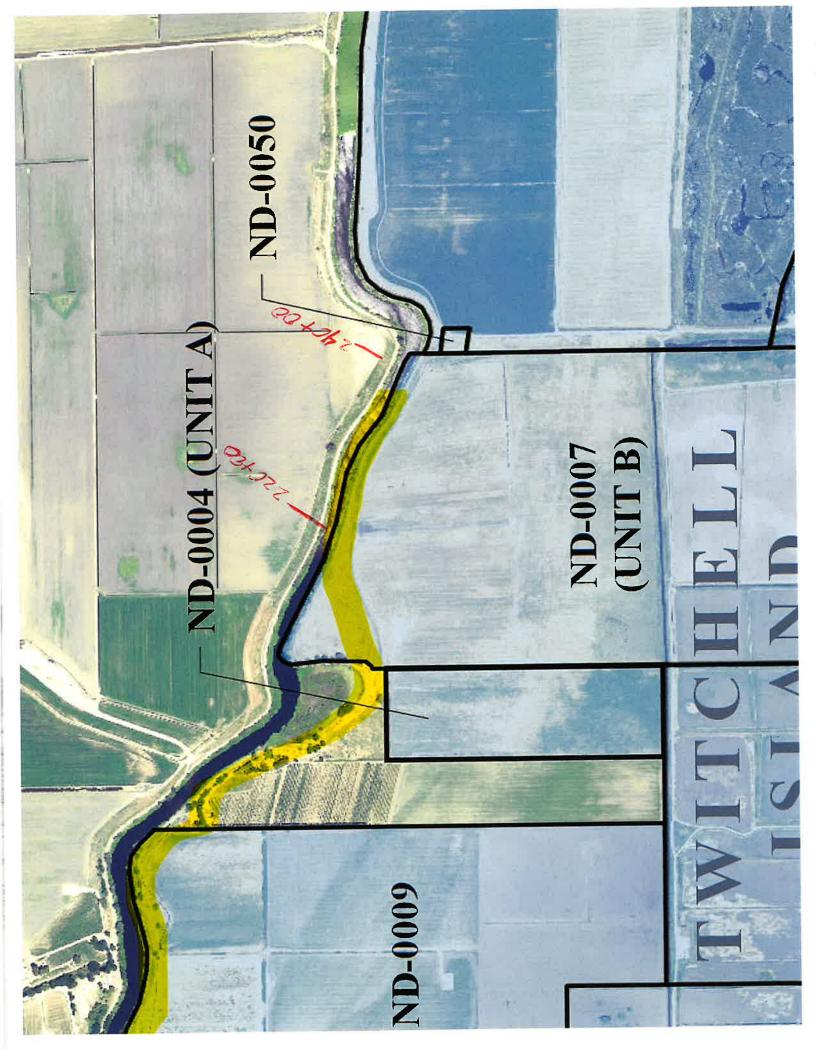

## Exhibit E

# Aloft InSAR for Levee Inspection

Aloft Interferometric Synthetic Aperture Radar (InSAR) systems are compact enough to fit onto small drones. Innovative algorithms provide high-resolution, exquisitely sensitive terrain and change detection maps. Two frequency bands support both broad-area and fine-scale infrastructure inspection needs. Aloft's systems can work stand-alone or coherently across multiple platforms.







Aloft X-band SAR on Tethered UAS


# **Aloft Mapping Products**


x-band: 15-cm resolution, mm change, broad area


Surface Deformation: sub-mm Height Accuracy: sub-cm Spallat Resolution: cm Expected Performance

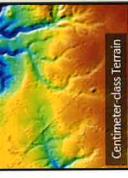

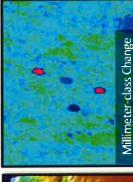

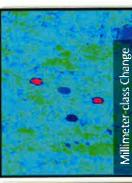

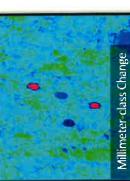

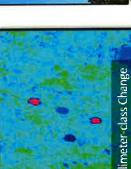



Levee Inspection with X-band and W-band InSAR

(10m-1km swath, sub-mm change accuracy)



Aloft Ultra-Sensitivity

Centimetric Resolution

© 2023 Aloft Sensing, Inc. Proprietary Information

Coordinated collection with multiple UAS ensures full shadow-free coverage.